
Right of Way (ROW) Standard Plans


TYPICAL CONCRETE CURB, GUTTER & SIDEWALK


NOTES:

- 1. SIDEWALK SLAB DEPTH: 4-INCH.
- 2. DRIVEWAY SECTION DEPTH: 6-INCH.
- 3. WATER METER LIDS LOCATED IN DRIVEWAY APPROACHES SHALL BE BE "IFCO": No. 2019, No. 2020 WITH DROP HANDLES TO BE USED IN SIDEWALK AREAS.
- 4. THROUGH 3/8-INCH EXPANSION JOINT IN BOTH CURB AND SIDEWALK, FULL DEPTH (SEE DETAIL A).
- 5. WATER METER LID SHALL BE PLACED NO CLOSER THAN 6-INCH FROM THE BACK OF THE SIDEWALK.
- 6. 1/8-INCH TO 1/4-INCH CONSTRUCTION JOINTS IN SIDEWALK ONLY. (SEE DETAIL B). THE CONSTRUCTION JOINT FROM NOTE 5 MAY BE MOVED TO BE ON ONE SIDE OF THE WATER METER LID WITH INSPECTOR'S APPROVAL.
- 7. FOR CURB & GUTTER REPLACEMENT, ASPHALT PAVEMENT REMOVAL BY SAW CUTTING FOR FORMS PLACEMENT (OR EXTRUDER MACHINE) IS REQUIRED. THE WIDTH OF 18—INCH MINIMUM TRANSVERSE SAW CUT IS BASED ON MULTIPLE COMPACTED LIFTS OF CRUSHED ROCK AND HOT MIX ASPHALT (H.M.A.) BY ITS ASSOCIATED COMPACTION EQUIPMENT, WIDER PAVEMENT REMOVAL MAY BE NECESSARY. SUBSEQUENT STREET PATCH TO MATCH EXISTING STREET SURFACING THICKNESS OR 3—INCH H.M.A. WHICHEVER IS GREATER.
- 8. TACK COAT MUST BE PLACED ALONG THE CUT FACE OF THE EXISTING ASPHALT PRIOR TO PATCHING WITH H.M.A.
- 9. LID ADJUSTMENTS SHALL BE DONE USING BRICK OR CONCRETE.
- 10. SIDEWALK WIDTH (5'-0" MIN.) AS SPECIFIED ON DRAWINGS OR IN CONTRACT.
- 11. SEE DETAIL R-100B FOR SECTIONS.

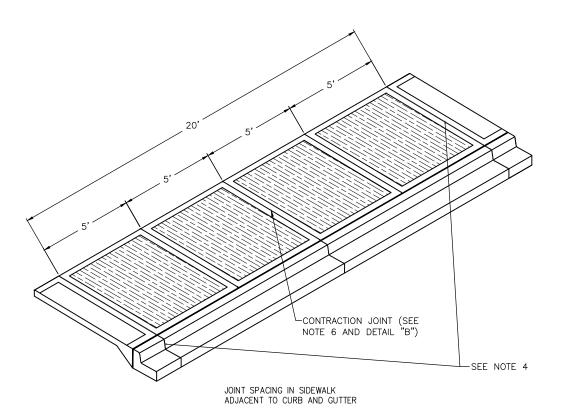

JOINT SPACING

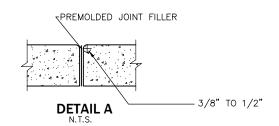


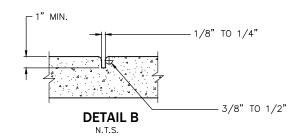

STANDARD DETAIL CURB, GUTTER, AND SIDEWALK

City of Wenatche


	SCALE: AS SHOWN	NMOH.	DATE DRAWN	REVISIONS)NS	
			3/23/2015	DATE	INITIAL	
F	DESIGNED	DRAWN	CHECKED	06/16	RDH	Ť
	DMN	RDH	DMN	09/20	CAW	
ГДII • 1	APPROVED BY	Α.	DATE APPROVED 01/22	01/22	SPA	
				03/31/2023	ATB.	
10. DA	STAN	STANDARD SPECIFICATIONS	CATIONS			
١.	8-04 CURBS & GUTTER	& GUTTER				
	8-06 DRIVEWAY	ξ¥				

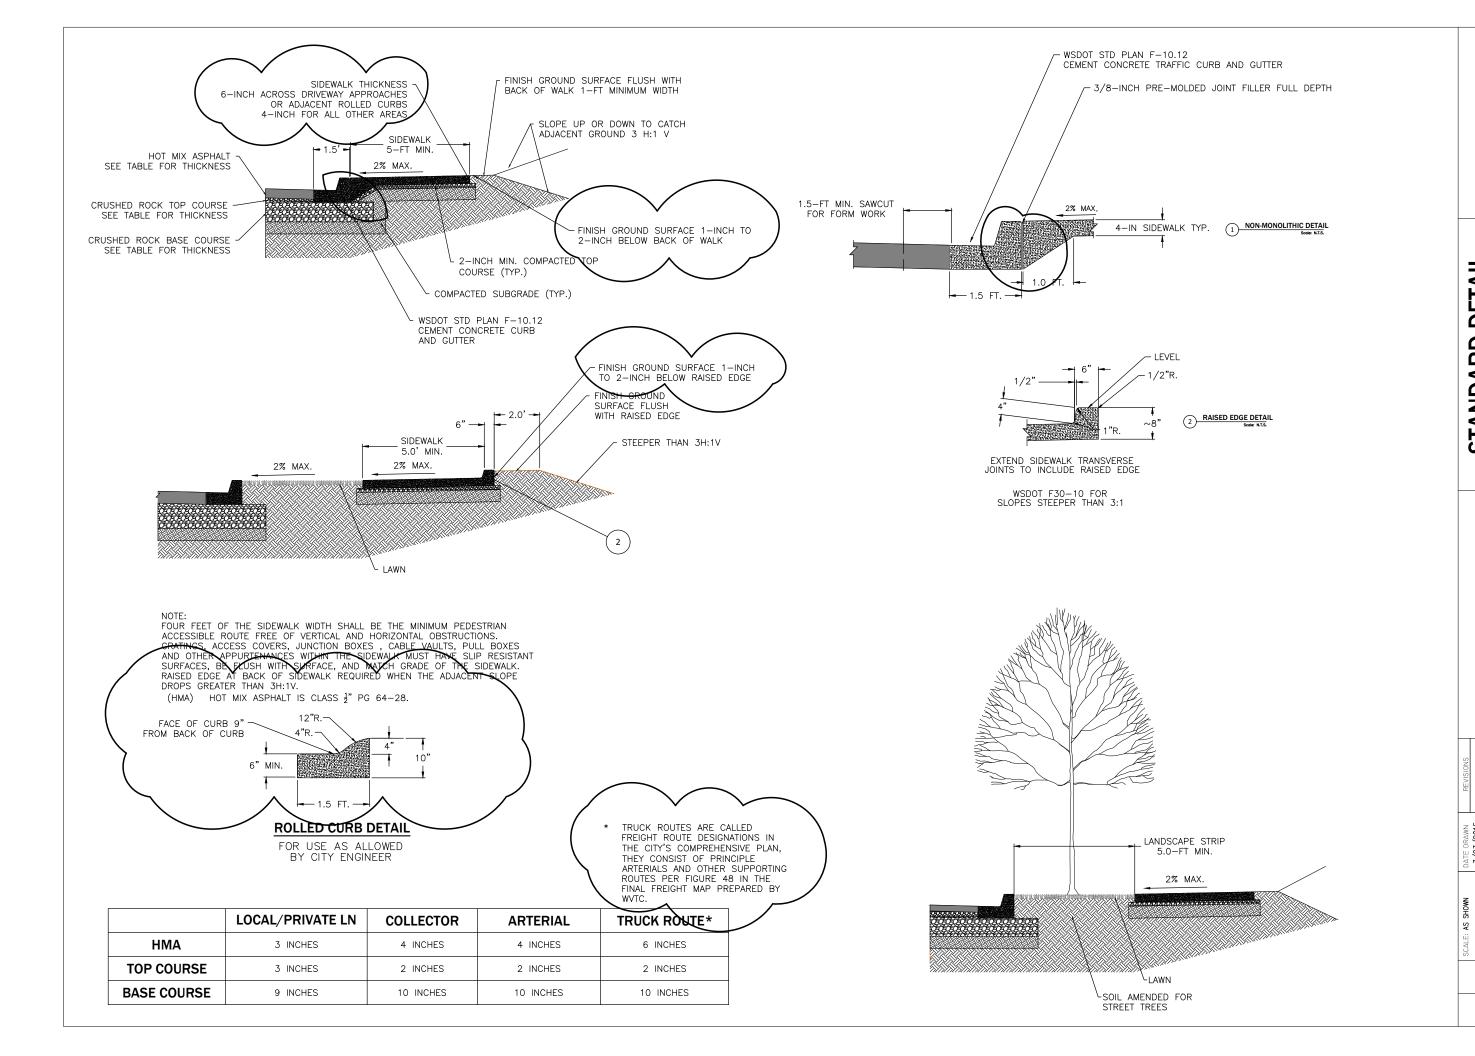

STANDARD DETAIL CURB, GUTTER, AND SIDEWALK

| DMN | DMN

R-100E

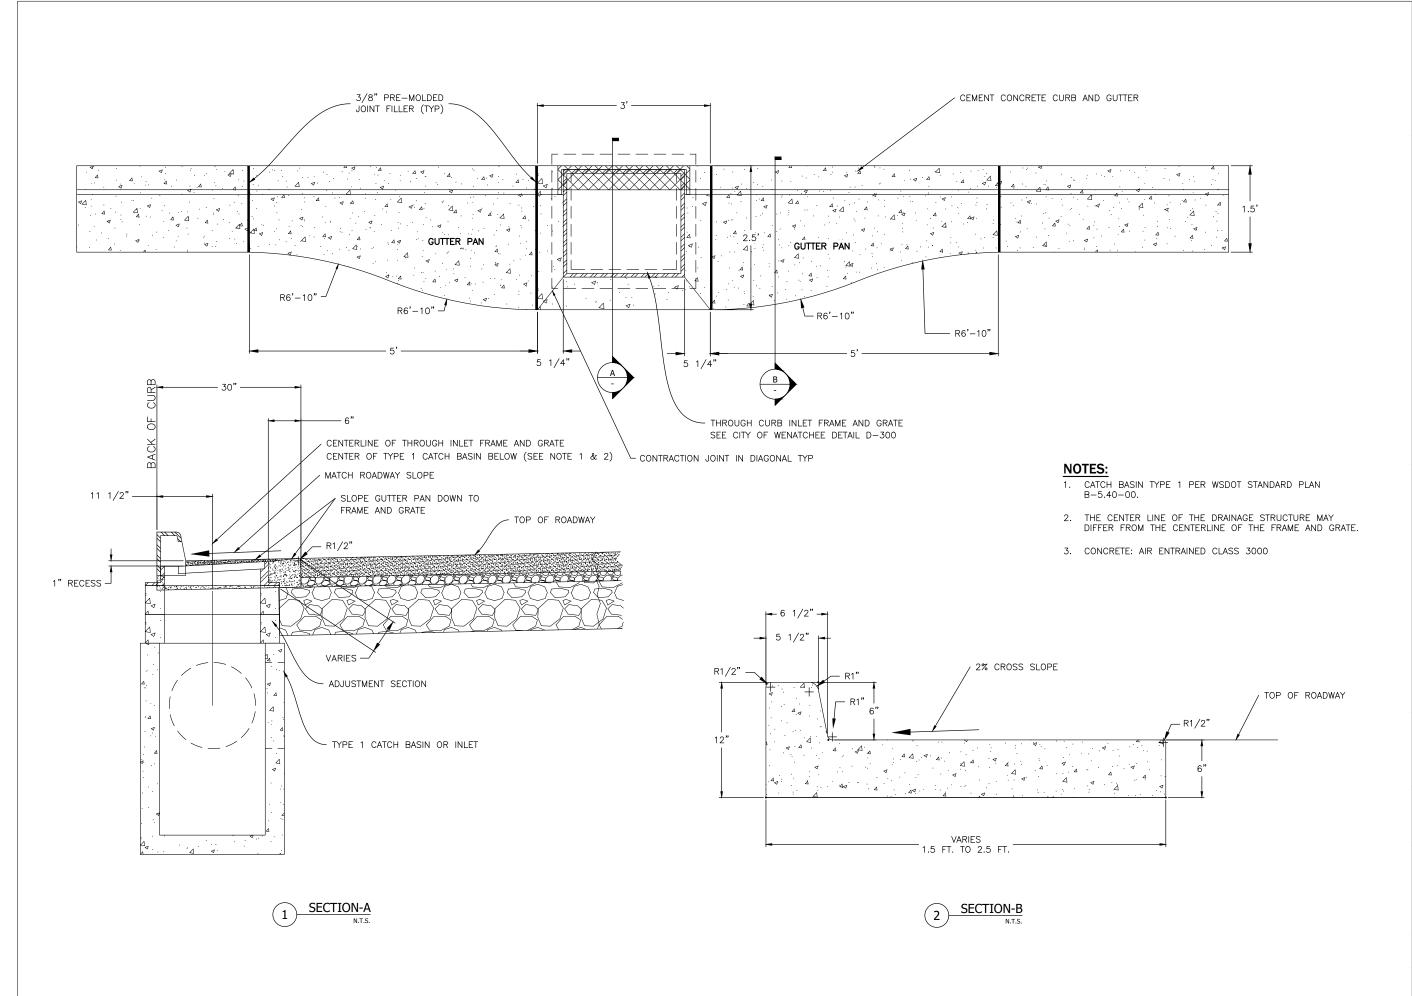


STANDARD DETAIL GUTTER PAN AT THROUGH CURB INLET



SCALE: AS SHOWN	SHOWN	5/31/2011	DATE INIT	INITIAL	
DMN	RDH	CIECKE	4/9/2015	RDH	
APPROVED BY	37	DATE APPROVED 12/21/2020	12/21/2020	CAW	
			01/01/2022	AJS	
STAN	STANDARD SPECIFICATIONS	CATIONS	03/31/2023	ATB.	
8-04 CURB	IS, GUTTERS, A	8-04 CURBS, GUTTERS, AND SPILLWAYS			

DETAIL NO. R-110


PAGE

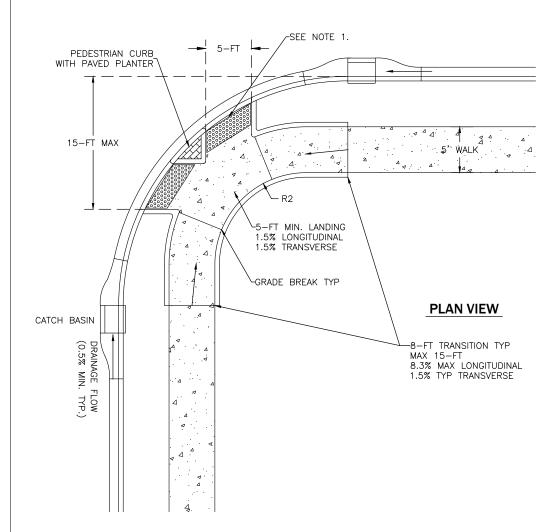


BI-DIRECTIONAL CURB RAMPS

NOTES:

- 1. DETECTABLE WARNING SURFACE PER WSDOT STD. PLAN F-45.10
- 2. RAMP AND APPROACHES SHALL BE CLEAR OF OBSTACLES INCLUDING HYDRANTS, POLES, AND INLETS.
- 3. RAMP CENTER LINE SHALL BE PERPENDICULAR TO THE RADIAL TO CURB RETURNS UNLESS OTHERWISE APPROVED BY ENGINEER.
- 4. CATCH BASINS SHALL BE PLACED UPSTREAM FROM PEDESTRIAN RAMPS, AS REQUIRED BY PROJECT DRAINAGE PLANS.
- 5. CURB SLOPE SHOULD NOT EXCEED 2% ACROSS RAMP. MAY BE INCREASED TO 5% AT NON-STOP CONTROLLED INTSECTIONS.
- 6. RAMP TO BE 4-FT WIDE WHEN CORNER IS PAVED OR 5-FT WIDE WHEN CORNER IS LANDSCAPED.

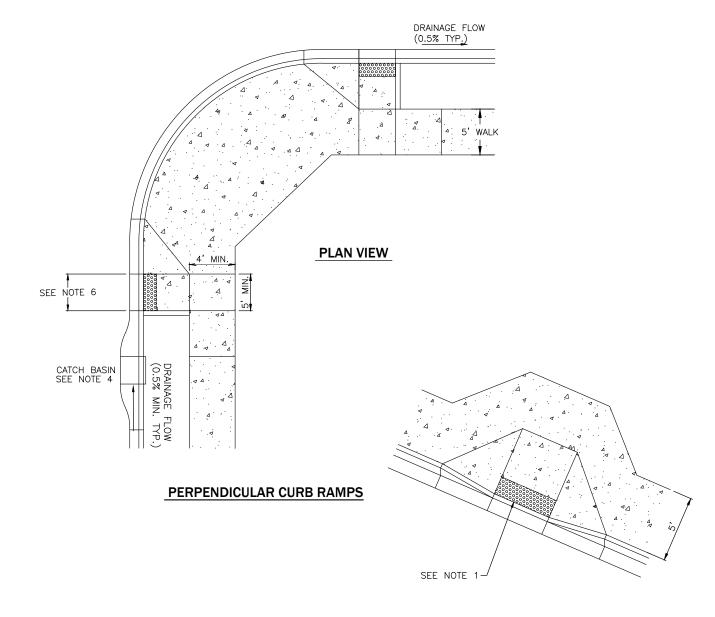

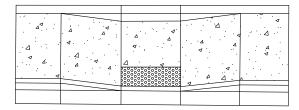

PARALLEL CURB RAMPS

STANDARD DETAIL DIRECTIONAL CURB RAMPS




SNS	INITIAL	EF)						
REVISIONS	DATE	02/31/2023 JTB						
DATE DRAWN	01/28/21	CHECKED		DATE APPROVED		CATIONS		
SCALE: AS SHOWN		DESIGNED DRAWN	CAW	APPROVED BY		STANDARD SPECIFICATIONS		
<u></u>		_	DE.	ΓΔΙΙ	L N	10.		

R-120

PAGE **1 OF 1**

1

0.5" R NOTE 3 **FLAT CURB**

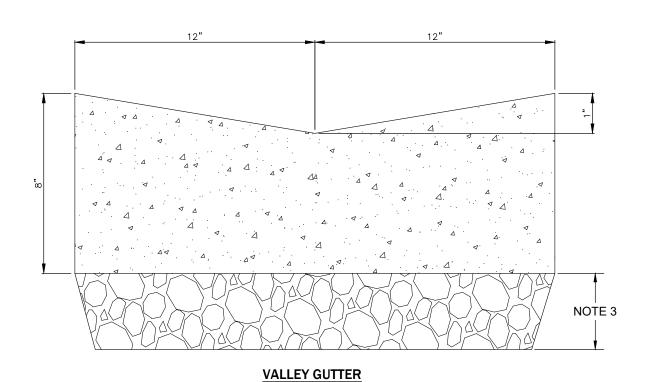

NOTES:

- 1. THIS DETAIL IS FOR SPECIAL USE ONLY WITH APPROVAL FROM PUBLIC WORKS INSPECTOR OR ENGINEER.
- 2. FORMS SHALL BE STEEL AND SET TRUE TO LINE AND GRADE (INSPECTION IS REQUIRED PRIOR TO PLACEMENT OF CONCRETE).
- 3. BASE COURSE SHALL BE 4-INCH COMPACTED DEPTH CRUSHED SURFACING TOP COURSE.
- 4. CONCRETE SHALL BE CEMENT CONCRETE CLASS 4000.
- 5. FOR CURB EXPANSION JOINT 20-FT OC WITH 10-FT CONTRACTION JOINT.

 6. BROOM FINISH ONLY.

STANDARD DETAIL **VALLEY GUTTER** FLAT CURB AND



NS	INITIAL	AJS	JTB				
REVISIONS	DATE	01/01/2022	03/31/2023				
DATE DRAWN	10/02/2020	CHECKED		DATE APPROVED	CATIONS		
SHOWN		DRAWN	CAW	37	STANDARD SPECIFICATIONS		
SCALE: AS SHOWN		DESIGNED		APPROVED BY	STAN		

DETAIL NO. R - 130

PAGE

MOUNTABLE MEDIAN CURB

N.T.S.

NOTES:

- 1. ALL ASPHALT JOINTS AND TAPERED TRANSITIONS SHALL BE SEALED IN ACCORDANCE WITH WSDOT STANDARD SPECIFICATIONS SECTION 5-03.
- 2. SEE R-305.

STANDARD DETAIL **MEDIAN CURB** MOUNTABLE



NMOH	DATE DRAWN	SNOISIA	SNS	
	10/02/2020	DATE	INITIAL	
DRAWN	CHECKED	01/01/2022	AJS	•
CAW		03/31/2023	JTB	
	DATE APPROVED			
ARD SPECIFICATIONS	CATIONS			
ADHESIVE FO	ADHESIVE FOR LANE MARKERS			

R-140

PAGE

- 1. ALL EXISTING ALLEYS SHALL HAVE A MINIMUM PAVEMENT WIDTH OF 12-FEET UNLESS APPROVED BY THE PUBLIC WORKS DEPARTMENT.
- 2. NEW ALLEYS SHALL HAVE A MINIMUM PAVEMENT WIDTH OF 20-FEET.
- 3. INVERT DRAINAGE TO BE COLLECTED AT LOW END OF IMPROVED SECTION WITH CATCH BASIN INSTALLATION AND TIGHTLINED TO STORM DRAIN SYSTEM.
- COMPACTION TESTS ON SUBGRADE AND ROCK GRADE SHALL BE REQUIRED. THE NUMBER OF TESTS SHALL BE AT THE DISCRETION OF THE CITY INSPECTOR. ALL TESTS, AS REQUIRED, SHALL BE AT THE EXPENSE OF THE CONTRACTOR OR DEVELOPER THROUGH ANY LICENSED TESTING LAB OF THEIR CHOICE. THE MINIMUM COMPACTION SHALL BE 95 % OF MAXIMUM DRY DENSITY (PER ASTM D1557) ON BOTH SUBGRADE AND ROCK SURFACES.
- 5. ADJUSTMENT OF CATCH BASIN LIDS OR GRATES, MANHOLE LIDS, MONUMENT CASES, VALVE BOXES, ETC., SHALL BE THE RESPONSIBILITY OF THE CONTRACTOR OR DEVELOPER AS REQUIRED AND SHALL BE ADJUSTED PER WSD R-330 AFTER THE FINAL LIFT OF ASPHALT HAS BEEN PLACED.


STANDARD DETAIL **CROSS-SECTION** ALLEY PAVED A



NS	INITIAL	CAW	JTB				
REVISIONS	DATE	9/2/2021	03/31/2023				
DATE DRAWN	10/01/2020	CHECKED		DATE APPROVED	ATIONS		
SCALE: AS SHOWN		DRAWN	CAW	D BY	STANDARD SPECIFICATIONS		
SCALE: A		DESIGNED		APPROVED BY	ST,		

R-150

PAGE

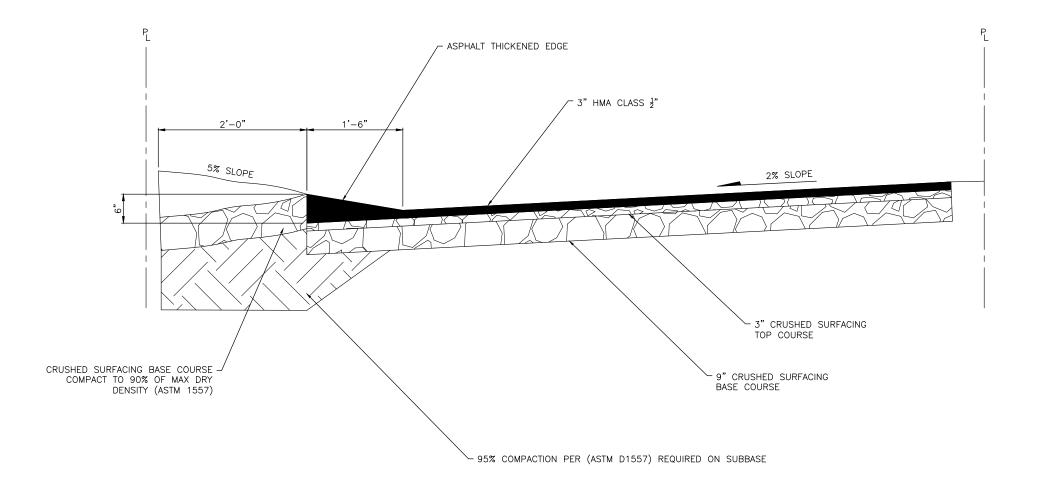

1. MAY BE USED FOR SPECIAL APPLICATIONS IN ALLEYS AS DETERMINED BY THE CITY ENGINEER.


STANDARD DETAIL SINGLE SLOPE PRIVATE ROADWAY



0	2	INITIAL	CAW	JTB					
0000	REVISIONS	DATE	9/2/2021	03/31/2023					
L ANT A CO	DATE DRAWN	10/02/2020	CHECKED		DATE APPROVED		ATIONS		
Tan Oil	NMOHS		DRAWN	CAW	BY		STANDARD SPECIFICATIONS		
L a	SCALE: AS SHOWN		DESIGNED		APPROVED BY		STAN		
Γ				DE.	ΓΔΙΙ	LN	0.		

R-160

PAGE

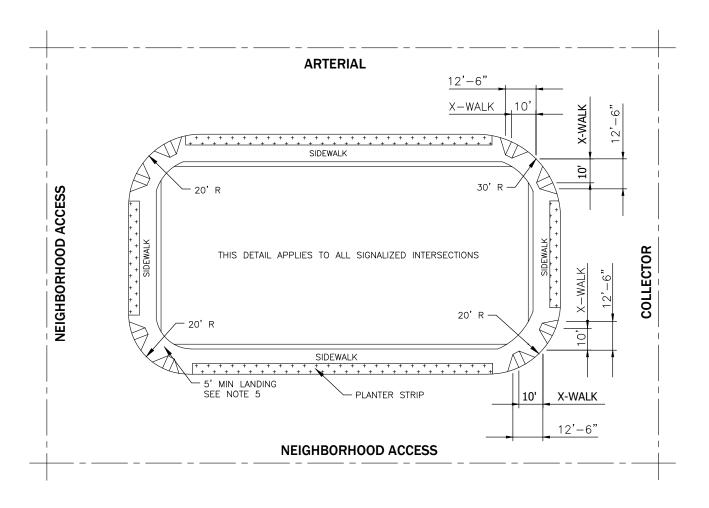


CURB RADIUS AT INTERSECTIONS

	ARTERIAL	COLLECTOR	NEIGHBORHOOD ACCESS
ARTERIAL	25-FT	25-FT	20-FT
COLLECTOR	25-FT	20-FT	20-FT
NEIGHBORHOOD ACCESS	20-FT	20-FT	20-FT

NOTES:

- 1. THE CITY OF WENATCHEE EVALUATES CURB RADII BASED ON THE TYPE AND VOLUME OF ACTIVITY AT THE INTERSECTION. IN ALL CASES, THE CITY WILL EVALUATE THE CURB RADII BASED ON A SINGLE UNIT (SU) VEHICLE WITH A 42 FOOT TURNING RADIUS. AN APPLICANT MAY PROPOSE TIGHTER CURB RADII, AND WILL NEED TO PROVIDE SUPPORTING DOCUMENTATION AND HAVE THE REQUEST APPROVED BY THE CITY ENGINEER.
- 2. STORM DRAINAGE INLETS SHALL BE OUTSIDE THE CURB RAMP.
- 3. THE CURB RAMP MAY BE MOVED AWAY FROM THE CROSSWALK TO AVOID CONFLICTS WITH HYDRANTS, POLES, INLETS, OR OTHER UTILITIES. EXCEPT WHERE THE STREET GRADE EXCEEDS 4%.
- 4. FOR SWEEPING EFFICIENCY, WHEN CURB BULBS (PARKING SETBACKS) ARE USED, REVERSE CURVE RADIUS SHALL NOT BE LESS THAN 20 FEET. REFER TO DETAIL A.
- 5. FOR STAKING PURPOSES, RAMPS MAY BE LOCATED PER QUARTER DELTA AND PUBLIC WORKS APPROVAL.
- 6. REFER TO WSDOT STANDARDS.

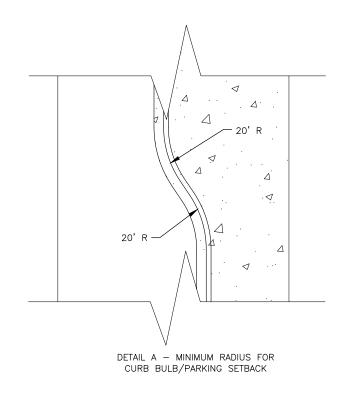

STANDARD DETAIL
STANDARDS & CURB
RAMP LOCATIONS




NS	INITIAL	AJS	JTB					
REVISIONS	DATE	01/01/2022 AJS	03/31/2023					
DATE DRAWN	10/05/2020	CHECKED		DATE APPROVED		ATIONS		
SCALE: AS SHOWN		DESIGNED DRAWN	CAW	APPROVED BY		STANDARD SPECIFICATIONS		
SC			DE.		L N	10.		

R-170

PAGE

1 OF 1

1

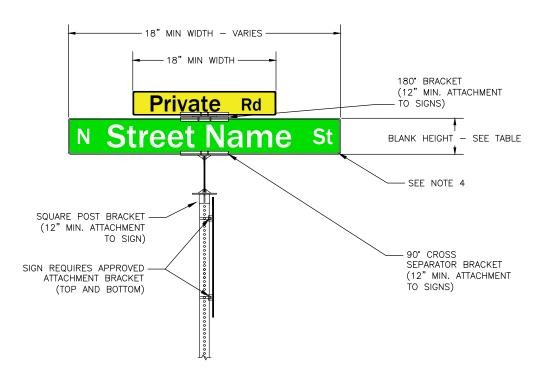

- 1. STOP SIGNS SHALL BE MUTCD R1-1. SIZES SHALL BE 30 X 30 MIN FOR SINGLE LANE ROADS, AND 36 X 36 FOR MULTI-LANE ROADS.
- 2. THE LETTERING FOR NAMES OF STREETS ON STREET NAME SIGNS SHALL BE COMPOSED OF A COMBINATION OF LOWER-CASE LETTERS WITH INITIAL UPPER-CASE LETTERS; IN COMPLIANCE WITH MUTCD 2009 EDITION AS DIRECTED BY THE WASHINGTON AMENDED CODE 486-95. THE BACKGROUND SHALL BE GREEN AND THE LEGEND AND BORDER SHALL BE WHITE. SEE THE TABLE BELOW FOR MINIMUM LETTERING HEIGHTS.
- 3. SUPPLEMENTARY LETTERING TO INDICATE THE TYPE OF STREET (SUCH AS STREET, AVENUE, OR ROAD) OR THE SECTION OF THE CITY (SUCH AS N OR S) ON THE STREET NAME SIGN SHALL BE IN SMALLER LETTERING, COMPOSED OF INITIAL UPPER-CASE LETTERS AT LEAST 3-INCHES IN HEIGHT AND LOWER-CASE LETTERS AT LEAST 2.25-INCHES IN HEIGHT. CONVENTIONAL ABBREVIATIONS MAY BE USED EXCEPT FOR THE STREET NAME ITSELF.
- THE ORIENTATION OF THE STREET NAME SIGN SHALL BE PARALLEL WITH THE STREET THAT IT NAMES.
- 5. THE MINIMUM INSTALLATION HEIGHT OF A POST-MOUNTED STREET NAME SIGN SHALL BE 9.5-FEET, IF NO STOP SIGN IS INSTALLED.
- 6. USE HIGHER CLASSIFICATION OF ROAD AT INTERSECTIONS
- 7. 0.125-INCH SHEET ALUMINUM FOR PERMANENT STREET NAME SIGNS. TYPE III OR IV REFLECTIVE SHEETING FOR BACKGROUND OF SIGNS. 0.080-INCH ALUMINUM SHEET THICKNESS FOR R-1 SIGNS AND OTHER MUTCD REGULATORY SIGNS.
- 8. CORNER RADII OF 1 1/2-INCHES.
- 9. SEE CITY STANDARD R11 FOR SIGN PLACEMENT DETAILS.
- 10. THE PRIVATE ROAD SIGN SHALL BE SIMILAR TO MUTCD W16-8P 2009 EDITION (ADVANCE STREET NAME PLAQUE WITHOUT ARROW AND ON YELLOW BACKGROUND WITH BLACK LEGEND AND BORDER TRIM.)
- 11. THE LETTERING HEIGHT FOR A PRIVATE ROAD SIGN SHALL BE 4-INCHES INITIAL UPPER-CASE AND 3-INCHES LOWER-CASE. THE ABRIVIATION "RD" FOR ROAD SHALL BE USED.
- 12. IF ROW PERMITS SIGN POST INSTALLATION BEHIND SIDEWALK, 12"-18" FROM BACK OF WALK PREFERRED.

		MINIMUM LI	ETTER HEIGHTS (ON STREET NAME	SIGNS (SEE NOTE	3)	
TYPE OF	D/D5 05 0TD55T	CDEED LIMIT	LETTER	HEIGHT	CURRI EMENTAL	DI ANIZ LIFICLIT	DODDED
MOUNTING	TYPE OF STREET	SPEED LIMIT	INITIAL UPPER-CASE	LOWER-CASE	SUPPLEMENTAL	BLANK HEIGHT	BORDER
OVERHEAD	ALL TYPES	ALL SPEED LIMITS	12 INCHES	9 INCHES	APPLE LOGO	18 INCHES	1½ INCHES
POST MOUNTED	ALL TYPES	ALL SPEED LIMITS	6 INCHES	4.5 INCHES	3-2.25 INCHES	9 INCHES	½ INCH


DETAIL STREE SIGN **STANDARD** AND NAME STOP




SNS	INITIAL	CAW	AJS	JTB				
REVISIONS	DATE	09/21	01/01/2022	03/31/2023				
DATE DRAWN	10/18/2012	CHECKED		DATE APPROVED 03/31/2023	:ATIONS	9-08 PAINT AND RELATED MATERIALS	AND FABRICATIONS	
SHOWN		DRAWN	DMN	14	STANDARD SPECIFICATIONS	AND RELATED	G MAIERIALS	
SCALE: AS SHOWN		DESIGNED	DMN	APPROVED BY	STAN	9-08 PAINT	NINIS 07-6	

DETAIL NO. R-200

PAGE

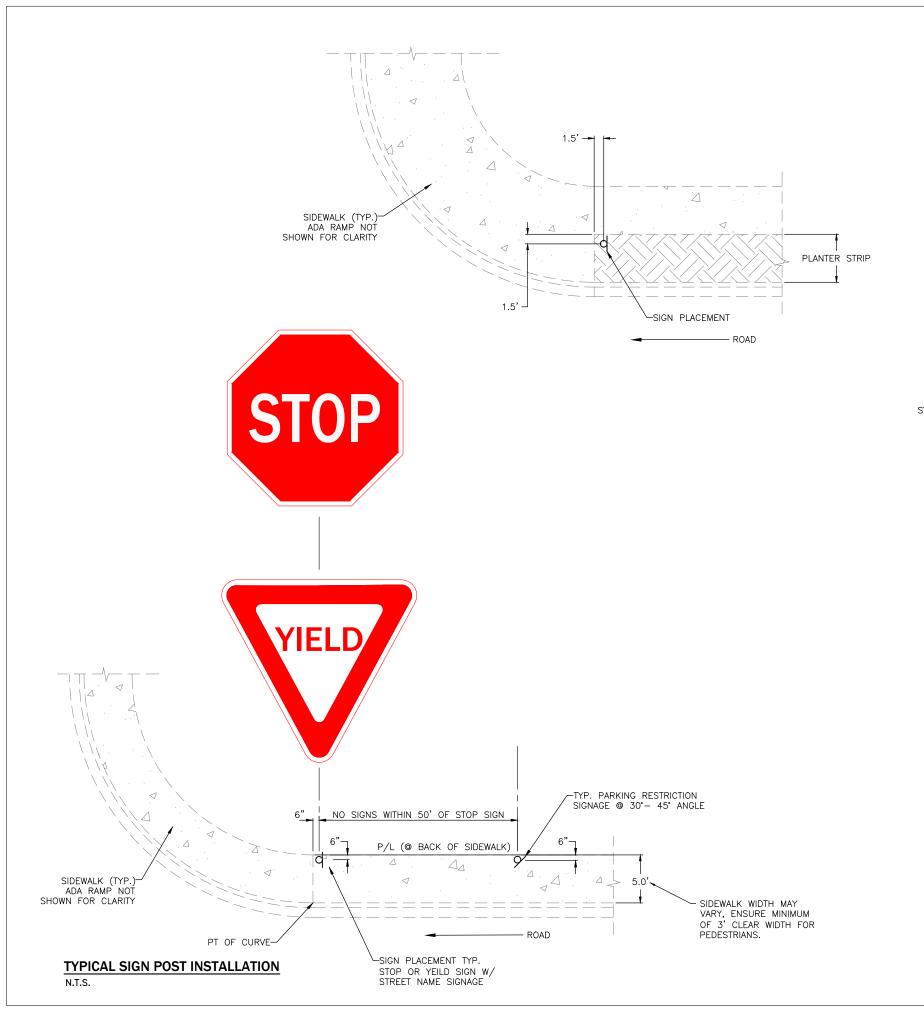

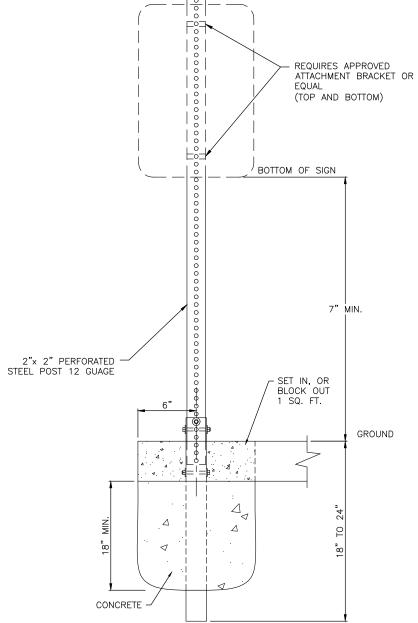



R7-1

- NOTES:
- 1. SEE R-200 FOR DETAILS ON BASE.
- 2. IF ROW PERMITS SIGN POST INSTALLATION BEHIND SIDEWALK, 12"-18" FROM BACK OF WALK PREFERRED.
- 3. NO PARKING SIGN MAY USE "HERE TO CORNER" IN PLACE OF "ANY TIME" OR AS SPECIFIED BY THE CITY.
- 4. REGULATORY MUTCD SIGNS THICKNESS 0.080—IN ALUMINUM SHEET FOR 36—IN AND SMALLER SIZES.

STANDARD DETAIL SIGN PLACEMENT NEAR SIDEWALKS




			DATE	INITIAL	
DESIGNED	DRAWN	CHECKED	09/21	CAW	
			01/12/2022 AJS	AJS	
APPROVED BY	*	DATE APPROVED 03/31/2023	03/31/2023	JTB	
STAND	STANDARD SPECIFICATIONS	CATIONS			
9-08 PAINT	9-08 PAINT AND RELATED MATERIALS	MATERIALS			
NINDIS 87-6	G MAIERIALS A	9-28 SIGNING MATERIALS AND FABRICATIONS			

R-210

PAGE

1 of 1

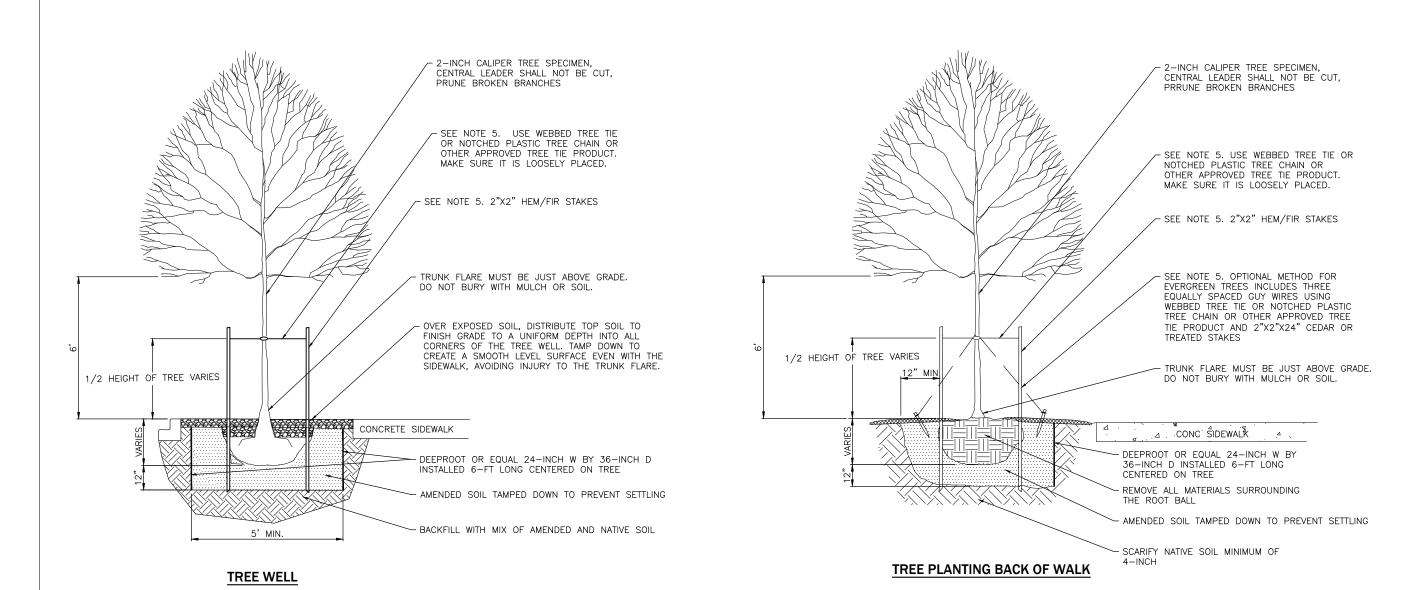

- 1. SIZE OF PLANTING PIT SHALL BE 3 TIMES LARGER THAN ROOT BALL.
- 2. FOR DECIDUOUS TREES, 2-INCH CALIPER MINIMUM AND BRANCHING STARTS 5-FT ABOVE GRADE (UNLESS OTHERWISE APPROVED BY THE CITY).
- 3. FOR PLANTING DISTANCES NEAR INTERSECTIONS AND DRIVEWAYS. REFER TO SIGHT DISTANCE STANDARDS.
- 4. TREES SHALL NOT BE PLANTED WITHIN 10-FT OF ANY UG UTILITY ACCESS, WHICH MAY BE LOCATED IN THE PLANTER STRIP OR ADJACENT SIDEWALK (UNLESS OTHERWISE APPROVED BY THE CITY).
- 5. REMOVE ALL MATERIALS SURROUNDING THE ROOT BALL.
- 6. STAKE IF REQUIRED BY THE CITY AND INCLUDE TIMELINE FOR REMOVAL OF STAKES AND TIES.
- 7. ROOT BARRIER TO BE DEEPROOT (OR APPROVED EQUAL) 24-INCH WIDTH BY 36-INCH DEPTH BY 6-FT LONG TOTAL INSTALLED ON BOTH CURB AND SIDEWALK SIDE.
- 8. NO EVERGREEN TREES IN PUBLIC RIGHT OF WAY.


STANDARD DETAIL TREE WELL



NS	INITIAL	AJS	JTB				
REVISIONS	DATE	01/01/2022 AJS	03/31/2023				
DATE DRAWN	10/20/2020	CHECKED		DATE APPROVED	CATIONS		
SHOWN		DRAWN	CAW	37	STANDARD SPECIFICATIONS		
SCALE: AS SHOWN		DESIGNED		APPROVED BY	STAN		

R-250

PAGE

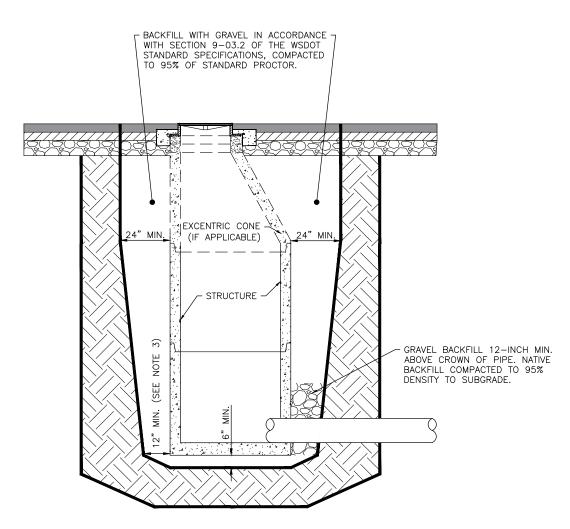

COMPACTION REQUIREMENTS FOR STORM DRAIN AND SANITARY SEWER STRUCTURES

NOTES:

- 1. STRUCTURES INCLUDE STORM DRAIN MANHOLES, CATCH BASINS, AND SANITARY SEWER MANHOLES.
- 2. REQUIREMENTS APPLY TO VALVE CANS AS SHOWN.
- 3. CLEARANCE SHALL BE LARGE ENOUGH TO USE A MECHANICAL COMPACTOR.
- 4. REFER TO CITY DETAIL R-330 FOR UTILITY ADJUSTMENTS.
- 5. BACKFILL SHALL BE COMPACTED IN A MAXIMUM OF 6-INCH LIFTS.

- BACKFILL WITH GRAVEL IN ACCORDANCE WITH SECTION 9-03.2 OF THE WSDOT STANDARD SPECIFICATIONS, COMPACTED TO 95% OF STANDARD PROCTOR.

VALVE CAN DETAIL

N.T.S.

STRUCTURE COMPACTION STANDARD DETAIL REQUIREMENTS




ᅜ	SCALE: AS SHOWN	DATE DRAWN	REVISIONS	SNS
		02/21/2006	DATE	INITIA
DRAWN		CHECKED	10/26/2020	CAW
RLK		JB	01/01/2022	AJS
APPROVED BY		DATE APPROVED 03/31/2023	03/31/2023	JIB
STANDARD SPECIFICATIONS	\simeq	CATIONS		

DETAIL NO. R-300

PAGE

TRENCH REPAIR CONSTRUCTION NOTES

- 1. HOT MIX ASPHALT SHALL BE PLACED IN TWO OR MORE LIFTS TO A MINIMUM TOTAL COMPACTED DEPTH OF 4-INCH OR MATCH THE EXISTING ASPHALT DEPTH. PORTLAND CEMENT CONCRETE STREETS SHALL BE PLACED TO A MINIMUM DEPTH OF 6-INCH OF CLASS 3000 COMMERCIAL GRADE CONCRETE OR MATCH EXISTING DEPTH, WHICHEVER IS GREATER.
- 2. IF PORTLAND CEMENT CONCRETE IS ENCOUNTERED UNDER EXISTING ASPHALT: THE CONTRACTOR SHALL REPLACE WITH 6-INCH OF CLASS 3000 COMMERCIAL GRADE CONCRETE OR MATCH THE DEPTH OF THE EXISTING CONCRETE, WHICHEVER IS GREATER.
- 3. SHOULD THE NUMBER OF CROSS TRENCHES (THOSE PERPENDICULAR TO THE DIRECTION OF THE ROADWAY) REPRESENT MORE THAN ONE TRENCH PER 75-FT OF THE STREET OF A GIVEN BLOCK AND THE TOTAL NUMBER OF TRENCHES EXCEEDS EIGHT, THE PERMITEE SHALL BE REQUIRED TO OVERLAY THE EXISTING ROADWAY SURFACE IF THE ROADWAY IS LESS THAN FIVE YEARS OLD. THE OVERLAY DEPTH SHALL BE SPECIFIED BY THE CITY ENGINEER.
- 4. IN THOSE CASES WHERE THE TRENCH IS GENERALLY RUNNING PARALLEL TO THE ROADWAY AND THE DISTANCE FROM THE EDGE OF THE ROADWAY IS LESS THAN 4-FT, THE CONTRACTOR SHALL REMOVE THE ROADWAY TO THE OUTER EDGE OF THE ROADWAY TO THE OUTER EDGE OF THE ROADWAY AND PAVE THIS AREA.
- 5. ALL PAVEMENT CUTS SHALL BE MADE WITH A SAW AND AFTER PLACEMENT OF TOP ROCK THE ROADWAY SHALL BE RE-CUT A DISTANCE OF EIGHT INCHES, OR GREATER AS DIRECTED BY THE CITY ENGINEER.
- 6. COMPACTED CRUSHED SURFACING SHALL BE USED FOR BACKFILL IN ALL TRANSVERSE CROSSING TRENCHES.
- 7. ALL ASPHALT JOINTS AND TAPERED TRANSITIONS SHALL BE SEALED IN ACCORDANCE WITH WSDOT STANDARD SPECIFICATIONS SECTION 5-03.
- 8. HOT MIX ASPHALT CL 1/2-INCH PG 64-28.

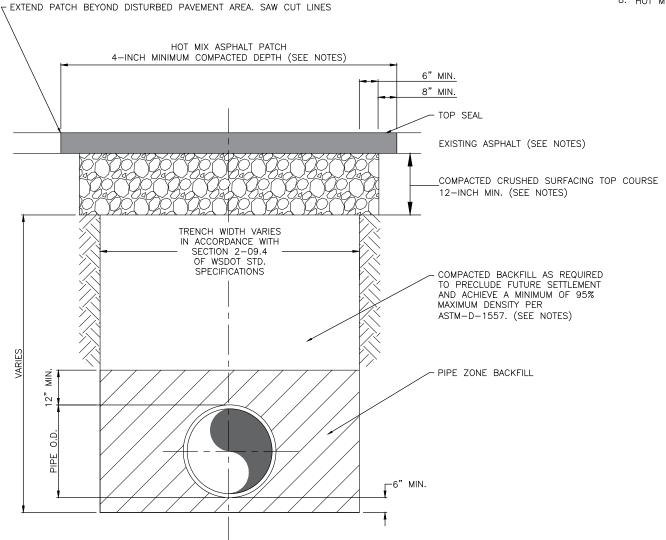


DETAIL COMPACTION REPAIR **STANDARD** TRENCH AND





SN	INITIAL	BP	CAW	AJS	JTB			
REVISIONS	DATE		09/21	01/01/2022	03/31/2023			
DATE DRAWN	02/06	CHECKED	SK	DATE APPROVED 01/01/2022		:ATIONS		
SCALE: AS SHOWN		DESIGNED DRAWN	RLK	APPROVED BY		STANDARD SPECIFICATIONS		


R - 305

PAGE

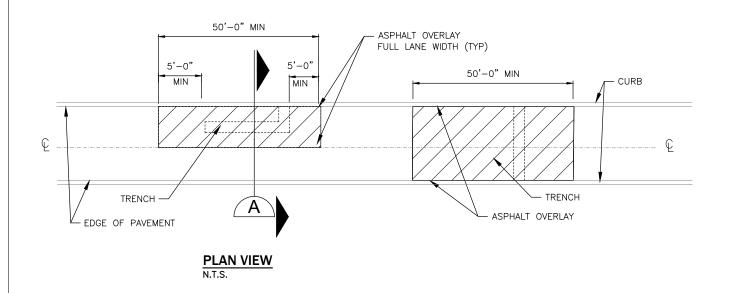


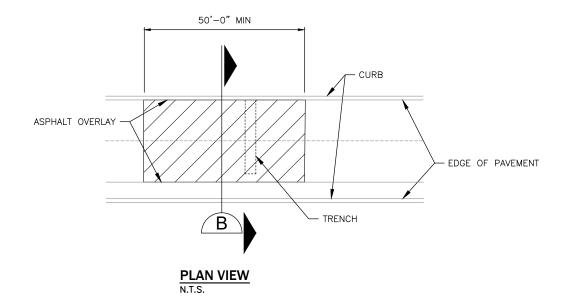

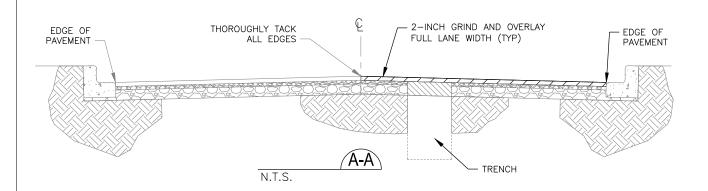

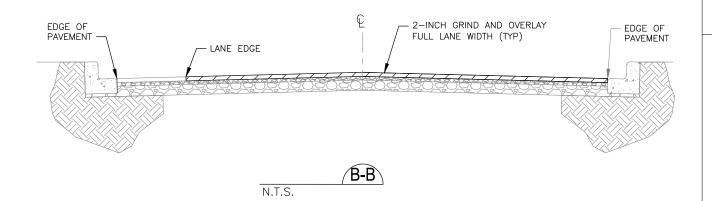

- 1. SEE CITY OF WENATCHEE POLICY R-2 FOR THE STREET ASPHALT OVERLAY POLICY. ONLY FOR ROADS RECENTLY OVERLAID WITHIN THE THE LAST 5 YEARS.
- 2. OVERLAY AREA MAY BE MODIFIED BY CITY ON OLDER PAVEMENT DEPENDING ON CONDITIONS OR SCHEDULED CONSTRUCTION/MAINTENANCE.
- 3. ADJUST ALL UTILITY CASTING TO FINISH GRADE AND RESTORE CHANNELIZATION AND LOOP DETECTORS.
- 4. POTHOLES TO BE RESTORED WITH A 1' T-CUT. IF AFTER THE 1' T-CUT THE PATCH IS MORE THAN 4'X4', A GRIND AND OVERLAY IS REQUIRED UNLESS OTHERWISE APPROVED BY PUBLIC WORKS. IF THE PATCH IS WITHIN 2 LANES OF TRAVEL, THE GRIND AND OVERLAY WILL BE REQUIRED ON BOTH LANES. 50-FT MIN. LENGTH.
- 5. INTENDED ONLY FOR DRIVING LANE.

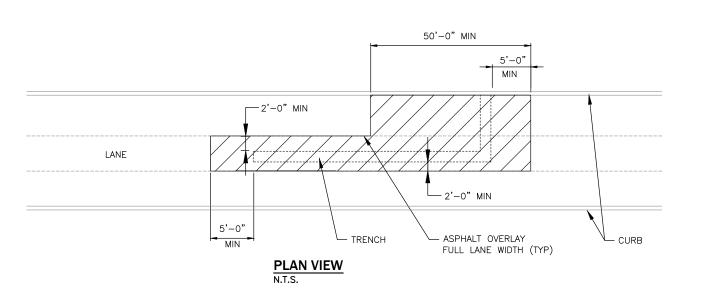

STANDARD DETAIL ASPHALT OVERLAY FOR TRENCH REPAIR




		Ŧ						
NS	INITIAL	AJS	JTB					
REVISIONS	DATE	01/01/2022 AJS	03/31/2023					
DATE DRAWN	10/02/2020	CHECKED		DATE APPROVED		CATIONS		
SHOWN		DRAWN	CAW	>-		STANDARD SPECIFICATIONS		
SCALE: AS SHOWN		DESIGNED		APPROVED BY		STAND		
			R-	TAII	∟ N 3 1	io. O		

FULL WIDTH COLD PLANING DETAIL

NOTES:

- 1. ALL JOINTS PLANED PERPENDICULAR TO TRAVEL LANES SHALL BE IMMEDIATELY PAPER JOINTED, COLD MIXED, AS PER THIS DETAIL, AND MAINTAINED UNTIL HMA LAYER IS INSTALLED. PAPER JOINTS WILL BE REMOVED JUST PRIOR TO PLACEMENT OF WEARING COURSES.
- 2. ALL COLD MIX RAMPS WILL USE A BUTT JOINT



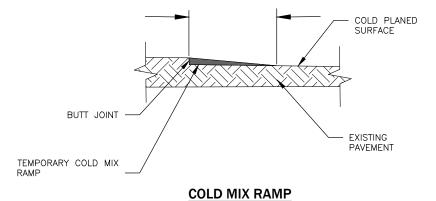

STANDARD DETAIL FULL WIDTH COLD PLANING DETAIL




_									
	NS	INITIAL	AJS	JTB					
	REVISIONS	DATE	01/01/2022 AJS	03/31/2023					
	DATE DRAWN	10/02/2020	CHECKED		DATE APPROVED		ATIONS		
	SHOWN		DRAWN	CAW	37		STANDARD SPECIFICATIONS		
	SCALE: AS SHOWN		DESIGNED		APPROVED BY		STAN		
ſ				DE.	ΓΔΙ	LN	0.		

R-320

PAGE

R-330

PAGE **1 OF 1**

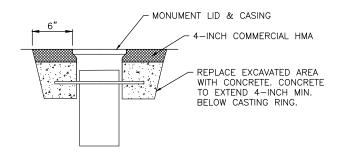


MONUMENT ADJUSTMENT DETAIL

N.T.S

WATER VALVE LID & CASING 4-INCH COMMERCIAL HMA REPLACE EXCAVATED AREA WITH CONCRETE TO EXTEND 4-INCH MIN. BELOW CASTING RING VALVE BOX

WATER VALVE ADJUSTMENT DETAIL

N.T.S.

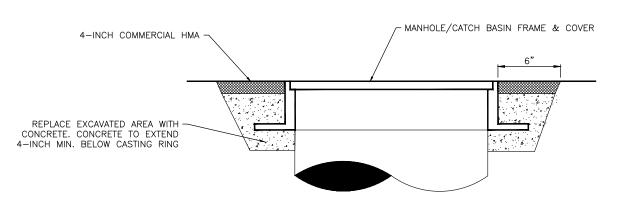


MANHOLE, CATCH BASIN ADJUSTMENT DETAIL N.T.S.

1. THE HIGHEST POINT ON THE CASING, RING, OR COVER SHALL BE NO LESS THAN FLUSH AND NO MORE THAN 1/2-INCH BELOW FINISHED GRADE.

2. USE PRE—CAST CONCRETE ADJUSTING RINGS TO RAISE THE FRAMES ON MANHOLES AND CATCH BASINS.

3. ADJUSTING RINGS SHALL BE GROUTED INSIDE AND OUT USING 6000 P.S.I. GROUT.


4. ASPHALT PATCH TO MATCH THE ADJACENT ASPHALT SURFACES.

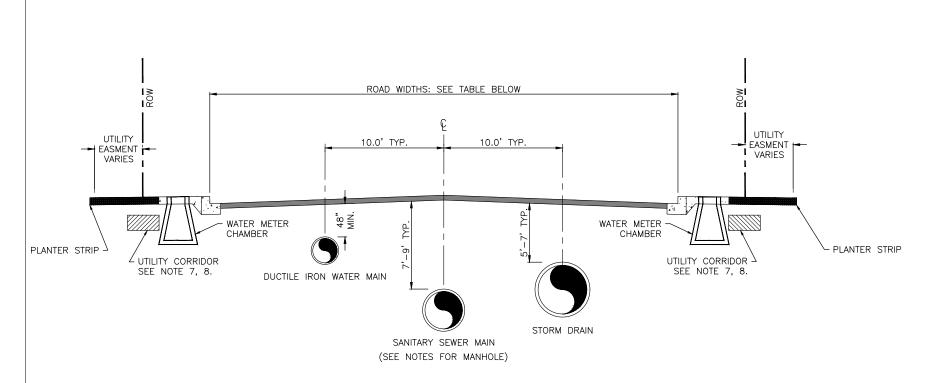

TYPICAL UTILITY PLACEMENT

N.T.S.

			ROAD WIDTH TABLE			
	PRIVATE LANE<500-FEET	RESIDENTIAL LANE	PRIVATE LANE>=500-FEET	LOCAL	COLLECTOR	ARTERIAL
CURB TO CURB (FT)	20	24	27	34	38	44-56

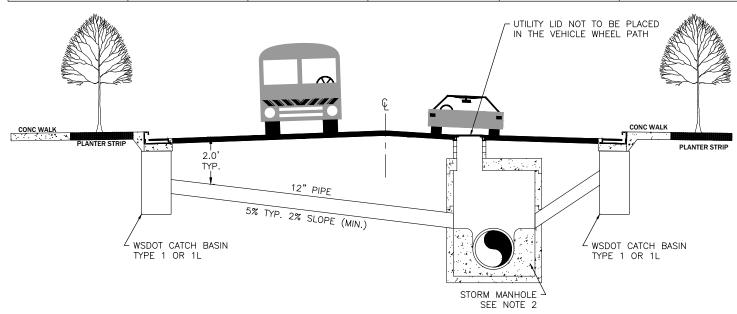

STORM SEWER CONFIGURATION

N.T.S.

NOTES:

- 1. SANITARY SEWER MANHOLES SHALL BE WSDOT MANHOLE TYPE 1 AND BE CHANNELIZED.
- 2. STORM SEWER MANHOLES SHALL BE WSDOT MANHOLE TYPE 3 AND BE CHANNELIZED.
- 3. THROUGH CURB INLET SHALL BE USED WITH ALL CATCH BASINS UNLESS OTHERWISE APPROVED.
- 4. ALL WATER & SEWER SEPARATION MUST BE DONE IN ACCORDANCE WITH DOE CRITERIA FOR SEWER WORKS DESIGN.
- 5. ALL CATCH BASINS SHALL HAVE A MINIMUM OF A 21" SUMP.
- 6. CATCH BASIN OUTLET PIPE TYPICAL 12" DIAMETER.
- 7. STORM SEWER LATERALS IN ACCORDANCE WITH D-200.
- 8. SANITARY SEWER LATERALS IN ACCORDANCE WITH S-100
- 9. STREET LIGHT CONDUITS SHALL BE PLACED ACCORDING TO STREET LIGHTING DETAILS. ALL OTHER UNDERGROUND UTILITIES SHALL BE PLACED BEHIND THE SIDEWALK SO AS NOT TO OBSTRUCT THE PLACEMENT OF FUTURE WATER CHAMBER.
- 10. THE UTILITY CORRIDOR SHOULD BE PLACED IN THE PLANTER STRIP RESERVING PLACEMENT FOR STREET TREES.

STANDARD DETAIL UTILITY LOCATIONS FOR NEW ROADS



SN	INITIAL	AJS	JTB			
REVISIONS	DATE	01/01/2022	03/31/2023			
DATE DRAWN	09/09/2021	CHECKED		DATE APPROVED	SATIONS	
SHOWN		DRAWN	CAW	37	STANDARD SPECIFICATIONS	
SCALE: AS SHOWN		DESIGNED	DMN	APPROVED BY	STAN	

DETAIL NO. R-350

PAGE

IN ROW




AS

R-400

1 OF 1

- CALL FOR CLEAR AND GRADE INSPECTION PRIOR TO BASE COURSE BEING PLACED. VERIFICATION OF ROCKERY HEIGHT, FOUNDATION MATERIAL, AND ROCK SIZE BY CITY CLEAR AND GRADE INSPECTOR IS REQUIRED.
- 2. 4-INCH TO 6-INCH QUARRY SPALLS SHOULD BE PLACED DIRECTLY FROM TRUCK OR OTHER SUITABLE CONTAINER IN ORDER TO MAINTAIN CLEAN BACKFILL.
- SPALLS MAY NOT BE NEEDED AT BASE OF ROCKERY IF NATIVE FOUNDATION MATERIAL IS SUITABLE AS DETERMINED BY THE GEOTECHNICAL ENGINEER OR THE CITY CLEARING AND GRADING INSPECTOR.
- 4. OPENINGS CHINKED WITH QUARRY SPALLS.
- 5. IF ROCKERY HEIGHT EXCEEDS 4-FEET, IT MUST BE DESIGNED BY A PRACTICING GEOTECHNICAL/CIVIL ENGINEER LICENSED IN THE STATE OF WASHINGTON. NO ROCKERY SHALL BE GREATER THAN 7-FEET IN HEIGHT UNLESS APPROVED BY CITY.
- 6. A ROCKERY GREATER THAN 4-FEET IN HEIGHT AND ON PRIVATE PROPERTY SHALL REQUIRE A BUILDING PERMIT WITH A THIRD PARTY INSPECTION TO BE CONSTRUCTED.
- 7. FILTER FABRIC SHALL BE MIRAFI 140 N SERIES OR APPROVED EQUAL.
- 8. OUTLET OF PERFORATED PIPE TO BE DETERMINED BEFORE CONSTRUCTION.

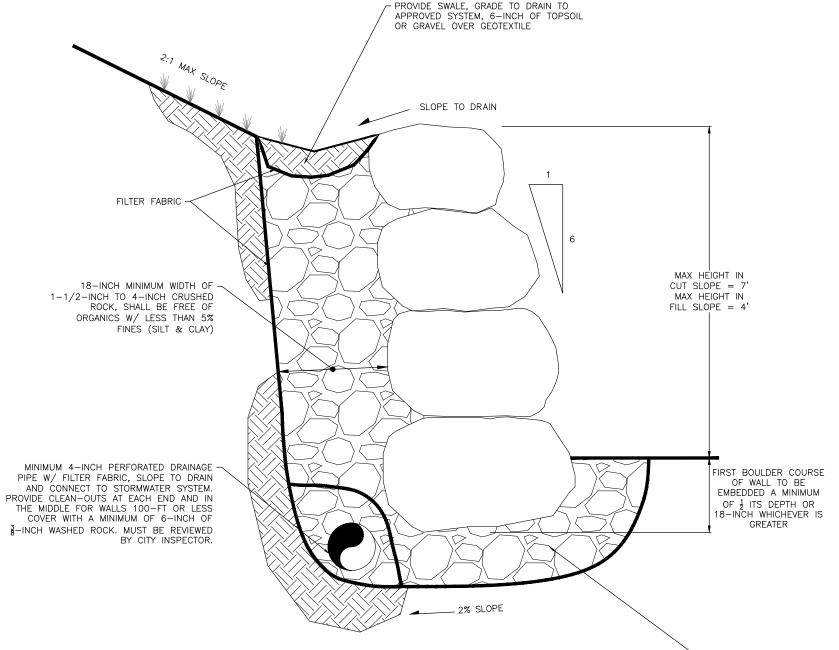

DEPTH OF CRUSHED ROCK/BASED COURSE TO BE 12—INCH OR AS SPECIFIED BY GEOTECH FOR WALLS 4—FT OR LESS PROVIDE 8-INCH DEPTH


- SAFETY RAILING PER CITY OF WENATCHEE STANDARD DETAIL R-450 4" SOD (TYP) - FILTER FABRIC (SEE NOTE 3) 8-INCH MINIMUM WIDTH OF 1-1/2-INCH TO 4-INCH CRUSHED ROCK. SHALL BE FREE OF ORGANICS W/ LESS THAN 5% FINES (SILT & CLAY) 4-INCH PERFORATED DRAINAGE PIPE W/ CONSTRUCTION GEOTEXTILE FOR SIDEWALK INFILL -SEPARATION. SLOPE TO DRAIN AND CONNECT TO STORMWATER SYSTEM. SECTION WIDTH TO BE DETERMINED PROVIDE CLEAN-OUTS AT EACH END AND BY THE CITY IN THE MIDDLE FOR WALLS 100-FT OR COVER WITH A MINIMUM OF 6-INCH OF 3-INCH WASHED ROCK. MUST BE REVIEWED BY CITY INSPECTOR. EXPANSION JOINT

SIDEWALK BELOW ROCKERY

ROCKERY HEIGHT (FT)	EMBEDMENT (D)	MIN ROCK SIZE (BASE)	MIN ROCK SIZE (TOP)
2	3 INCHES	2-MAN	1-MAN
4	6 INCHES	3-MAN	2-MAN
6	9 INCHES	4-MAN	2-MAN
7	12 INCHES	5-MAN	2-MAN

NOTES:

- 1. ROCKERY MUST BE INSTALLED BY LICENSED CONTRACTOR.
- IF ROCKERY HEIGHT EXCEEDS 4-FEET, IT MUST BE DESIGNED BY A PRACTICING GEOTECHNICAL/CIVIL ENGINEER LICENSED IN THE STATE OF WASHINGTON.
- 3. FILTER FABRIC SHALL BE MIRAFI 140 N SERIES OR APPROVED EQUAL.
- 4. IF ROCKERY IS CLOSER THAN 1V:1H BELOW FACE OF CURB TO BACK OF BASE EMBEDMENT ROCK. IT MUST BE DESIGNED BY AN ENGINEER TO INCLUDE TRAFFIC LOADING OF 250-PSF SURCHARGE.

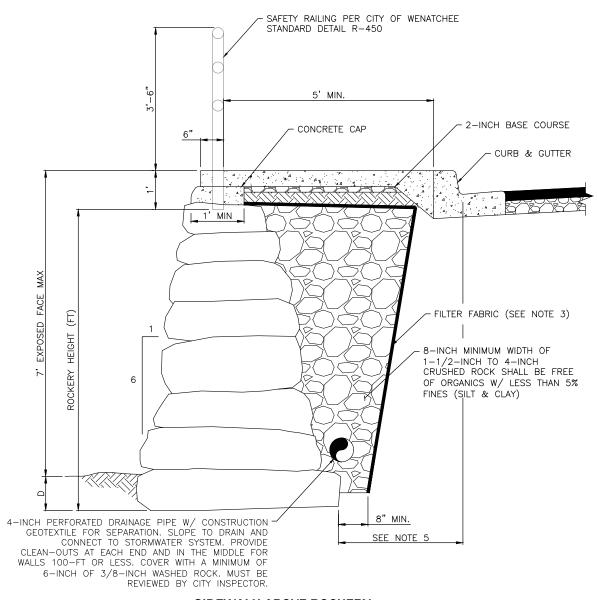

SIDEWALK ABOVE ROCKERY


STANDARD DETAIL ROW ROCKERY DETAIL SIDEWALK SUPPORT



				0.101011	2
			10/22/2020	DATE	INI
	DESIGNED	DRAWN	CHECKED	01/01/2022	AJS
DE.		CAW		03/31/2023	JTB
ΓΔΙ	APPROVED BY	, , , , , , , , , , , , , , , , , , ,	DATE APPROVED		
LN					
10.	STAN	STANDARD SPECIFICATIONS	CATIONS		

R-410

PAGE 1 OF 1

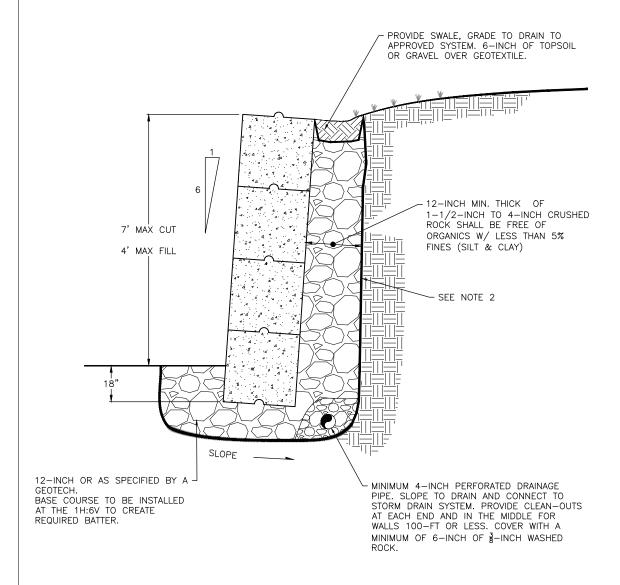


- METAL LIFT RING **CONCRETE TONGUE AND GROOVE BLOCK**

SIZES

Н	L	w
2'-0"	3'-0"	2'-0"
2'-0"	6'-0"	2'-0"

NOTES:

- MAX DEPTH OF CUT SHALL BE 8 FEET, AND MAX DEPTH OF FILL SHALL BE 4 FEET OR AS APPROVED BY GEOTECHNICAL ENGINEER. IN ANY CASE, THE CITY MAY REQUIRE INSPECTION AND APPROVAL BY A GEOTECHNICAL ENGINEER.
- 2. FILTER FABRIC SHALL BE MIRAFI 140 N SERIES OR APPROVED EQUAL.
- 3. SPALLS MAY NOT BE NEEDED AT BASE OF ROCKERY IF NATIVE FOUNDATION MATERIAL IS SUITABLE AS DETERMINED BY THE GEOTECHNICAL ENGINEER OR THE CITY OF WENATCHEE.

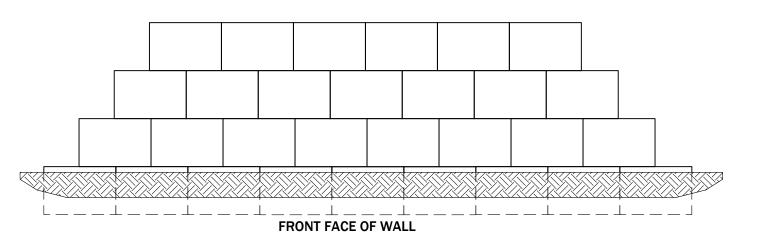


STANDARD DETAIL BLOCK ROW WALL IN **ECOLOGY**




S SHOWN	DATE DRAWN	REVISIONS	NS	
	10/23/2020	DATE	INITIAL	
DRAWN	CHECKED	9/3/2021	CAW	Ŧ
CAW		2	AJS	
DBY	DATE APPROVED 03/31/2023	03/31/2023	JTB	
ANDARD SPECIFICATIONS	CATIONS			

R-420

PAGE

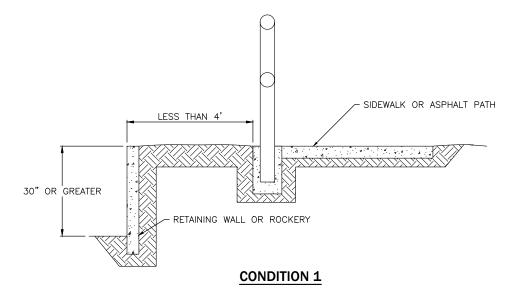

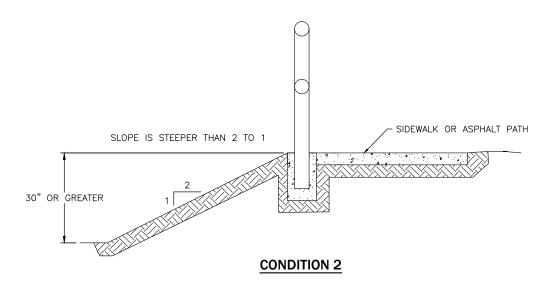

- SAFETY RAIL TYPE AND INSTALLATION TO BE SPECIFIED BY THE REVIEW ENIGINEER.
- 2. SEE R-451 AND R-452 FOR SAFETY RAILINGS.


STANDARD DETAIL CONDITIONS REQUIRING SAFETY RAILINGS



SCALE: AS SHOWN	NWOH	DATE DRAWN	REVISIONS	S.Z.
		10/20/2020	DATE	INITIAL
DESIGNED	DRAWN	CHECKED	03/31/2023 JTB	JE
	CAW			
APPROVED BY	۱.	DATE APPROVED		
STANE	STANDARD SPECIFICATIONS	ATIONS		

DETAIL NO.
R-450A

PAGE **1 OF 3**

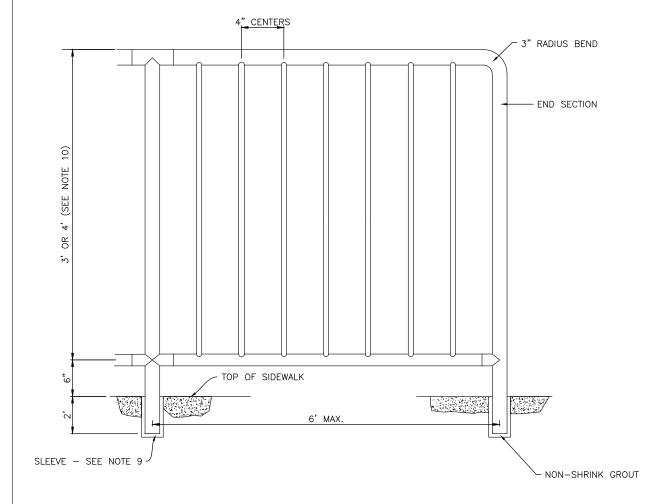

PIPE SCHEDULE

(ALL DIMENSIONS O.D.)

PANEL HEIGHT	TOP RAIL/POST	BOTTOM RAIL	BALUSTER
36"	1.90"	1.90"	.840"
42"	2.875"	2.375"	.840"

NOTES:

- RAILING SHALL BE ALUMINUM PIPE RAIL OR APPROVED EQUIVALENT. INSTALLATION PER MANUFACTURER'S
- 2. SHOP DRAWINGS OF RAILING SHALL BE SUBMITTED FOR APPROVAL SHOWING COMPLETE DIMENSIONS AND DETAILS OF FABRICATION AND INCLUDING AN ERECTION DIAGRAM. MATERIALS BEING USED SHALL BE SPECIFIED
- 3. ALL ALUMINUM PARTS SHALL BE GIVEN A CLEAR ANODIC COATING AT LEAST 0.0006 INCHES THICK AND BE HOT WATER SEALED AND SHALL HAVE UNIFORM FINISH.
- 4. PIPE RAILING AND PIPE RAILING SPLICES MAY BE HEATED TO NO MORE THAN 400'F FOR A PERIOD TO EXCEED 30 MINUTES TO FACILITATE FORMING OR BENDING.
- 5. CUTTING SHALL BE DONE BY SAWING OR MILLING AND ALL CUTS SHALL BE TRUE AND SMOOTH. FLAME CUTTING WILL NOT BE PERMITTED.
- 6. PIPE RAILING, PIPE BALUSTERS AND PIPE RAILING SPLICES SHALL BE ADEQUATELY WRAPPED TO ENSURE SURFACE PROTECTION DURING HANDLING AND TRANSPORTATION TO THE JOB SITE.
- 7. WELDING OF ALUMINUM SHALL BE IN ACCORDANCE WITH THE LATEST AASHTO STANDARD SPECIFICATIONS FOR STRUCTURAL SUPPORTS FOR HIGHWAY SIGNS, LUMINAIRES AND TRAFFIC SIGNALS.
- 8. ALLOW FOR EXPANSION AT APPROXIMATELY EVERY FOURTH POST.
- 9. RAILS, POSTS AND FORMED ELBOWS SHALL BE A.S.T.M. B-241 OR B-429 ALLOY, 6063-T6 SCHEDULE 40 (STD. PIPE). BRACKETS, ENDCAPS AND OTHER FITTINGS SHALL BE A.S.T.M. 6063-T5. SPLICES AND REINFORCING SLEEVES SHALL BE DRAWN ALUMINUM TUBING 6063-T832. SLEEVE I.D. SHALL BE 1" GREATER
- 10. PANEL HEIGHT: 36 INCHES FOR PEDESTRIAN USES 42 INCHES FOR BIKE PATHS.


STANDARD DETAIL SAFETY RAILING SIDEWALK



REVISIO	AWN CHECKED DATE INITIAL CAW	DATE APPROVED) SPECIFICATIONS			
---------	------------------------------	---------------	------------------	--	--	--

R-450B

PAGE

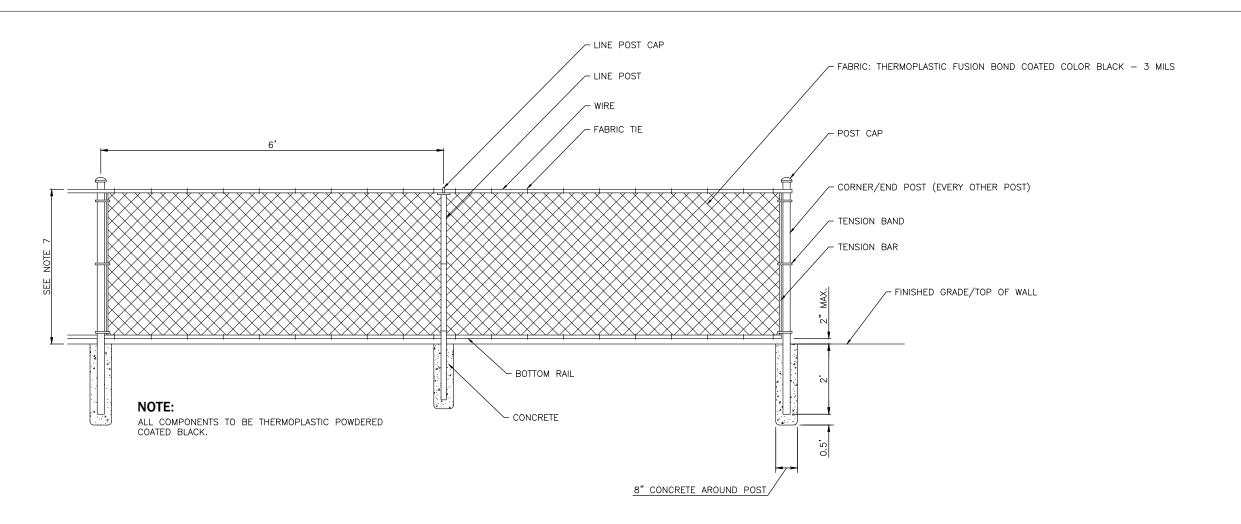

PIPE SCHEDULE

(ALL DIMENSIONS I.D.)

BOTTOM RAIL	CORNER/END POST	LINE POST
1.25"	2.5"	2"

NOTES:

- ALL FENCING MATERIALS SHALL COMPLY WITH THE WSDOT/APWA STANDARD SPECIFICATIONS SECTION 9-16 CLASS 1 MATERIAL. INSTALLATIONS PER MANUFACTURER'S RECOMMENDATIONS.
- 2. SHOP DRAWINGS OF RAILING SHALL BE SUBMITTED FOR APPROVAL SHOWING COMPLETE DIMENSIONS AND DETAILS OF FABRICATION AND INCLUDING AN ERECTION DIAGRAM. MATERIALS BEING USED SHALL BE SPECIFIED IN THE SHOP DRAWINGS.
- 3. ALL STEEL PARTS SHALL BE GIVEN A BLACK ULTRAVIOLET—INSENSITIVE THERMOPLASTIC POWDER COATING AT LEAST 3 MILS THICK AND SHALL HAVE A UNIFORM FINISH.
- 4. CUTTING SHALL BE DONE BY SAWING OR MILLING AND ALL CUTS SHALL BE TRUE AND SMOOTH. FLAME CUTTING WILL NOT BE PERMITTED.
- 5. ALL MATERIALS SHALL BE ADEQUATELY WRAPPED TO ENSURE SURFACE PRROTECTION DURING HANDLING AND TRANSPORTATION TO THE JOB SITE.
- 6. ANY WELDING OF STEEL SHALL BE IN ACCORDANCE WITH THE LATEST AASHTO STANDARD SPECIFICATIONS FOR STRUCTURAL SUPPORTS FOR HIGHWAY SIGNS, LUMINARIES AND TRAFFIC SIGNALS.
- 7. PANEL HEIGHT: 36 INCHES FOR ALL PEDESTRIAN USES 42 INCHES FOR BIKE PATHS


STANDARD DETAIL CHAIN LNK SIDEWALK




					-
SCALE: AS SHOWN			DATE DRAWN	REVISIONS	
10	10	=	10/21/2020	DATE INITIAL	
DESIGNED DRAWN CH		٥	CHECKED		
CAW	CAW				
APPROVED BY DA		ă	DATE APPROVED		
STANDARD SPECIFICATIONS	DARD SPECIFICAT	TA:	SNOI		

R-450C


PAGE **3 OF 3**

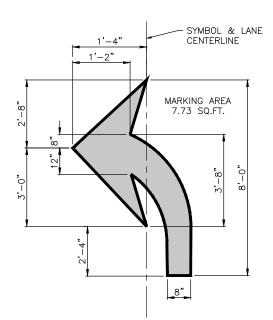

WSDOT STANDARD PLAN M-24.40-02 **TURN ARROW** N.T.S.

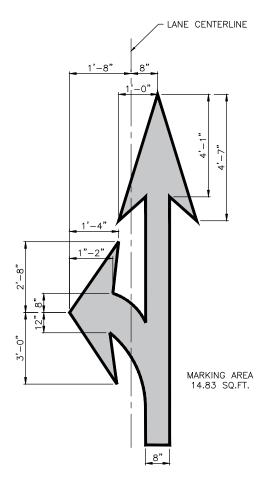

WSDOT STANDARD PLAN M-24.40-02 **COMBINATION ARROW** N.T.S.

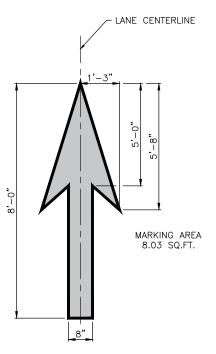

WSDOT STANDARD PLAN M-24.40-02 STRAIGHT ARROW N.T.S.

PAVEMENT MARKINGS STANDARD DETAIL **ARROW**




SN	INITIAL	CAW	AJS				
REVISIONS	DATE	12/21/2020	01/01/2022				
DATE DRAWN	02/21/2006	CHECKED	Ж	DATE APPROVED	SNOIL		

		02/21/2006	Ó
DESIGNED	DRAWN	CHECKED	12
	RLK	SK	10
APPROVED BY	14	DATE APPROVED	
STANE	STANDARD SPECIFICATIONS	CATIONS	

DETAIL NO. R-500A

PAGE

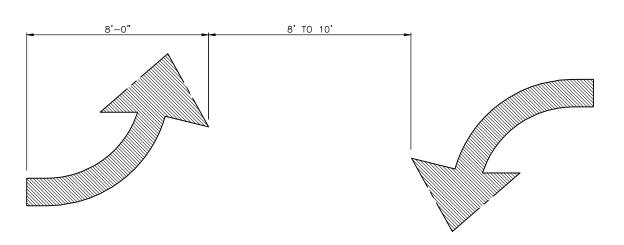

TYPICAL ARROW

NOTES

- 1. LONG LINE MARKINGS SHALL BE PAVEMENT MARKING MATERIAL PER SECTION9.34.1 TYPE D MMA
- 2. TRANSVERSE AND SYMBOL MARKINGS SHALL BE PAVEMENT MARKING MATERIALS PER SECTION 9-34.1 TYPE A

STANDARD DETAIL TWO-WAY LEFT TURN AND TYPICAL ARROW





RAWN REVISIONS	/2020 DATE INITIAL	. 01/01/2022 AJS .	03/31/2023 JTB	_			
ATE DRAWN	0/05/2020	HECKED		ATE APPROVED	SNOIJ		

			7 (00 (0)
	DESIGNED	DRAWN	CHECKED
DE:		CAW	
TΛΙ	APPROVED BY	Α	DATE APF
N			
0	STAND	STANDARD SPECIFICATIONS	ATIONS.
	8-22 PAVEMI	8-22 PAVEMENT MARKING	

R-500B


PAGE

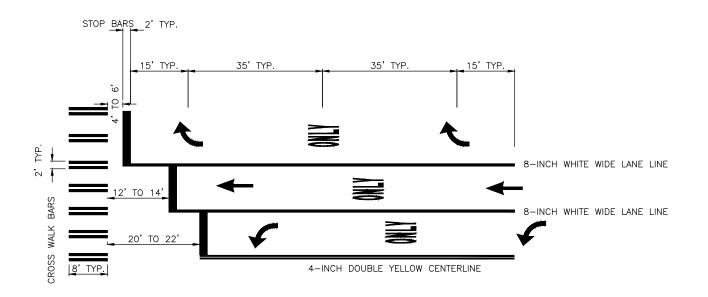

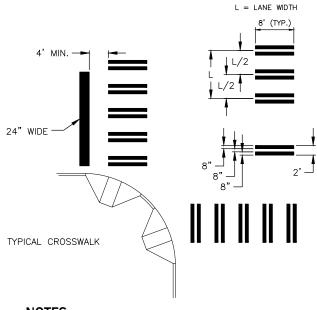

- 1. LOWER LANDING OF CURB RAMP SHALL FALL WHOLLY WITHIN CROSWALK LINES.
- 2. EXACT LOCATION OF CROSSWALK SHALL BE APPROVED BY THE CITY OF WENATCHEE.
- 3. EXISTING CROSSWALK MARKINGS THAT CONFLICT WITH NEW CROSSWALK MARKINGS SHALL BE REMOVED BY GRINDING.
- 4. MATERIAL SHALL BE TYPE A THERMOPLASTIC MATERIAL.

STANDARD CROSSWALK AND STOP BAR DETAIL

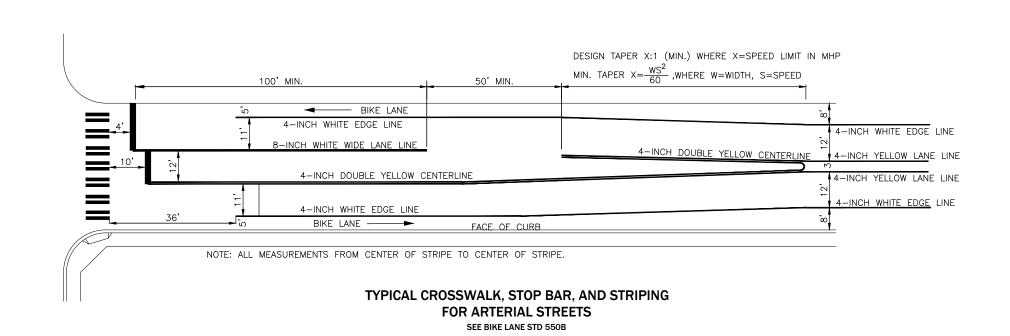


STANDARD DETAIL PAVEMENT MARKING LAYOUT



		Ŧ					
SN	INITIAL	AJS	JTB				
REVISIONS	DATE	01/01/2022	03/31/2023				
DATE DRAWN		CHECKED		DATE APPROVED	PECIFICATIONS		
		7	*		ECIFI(RKING	

DESIGNA APPRO

R-510

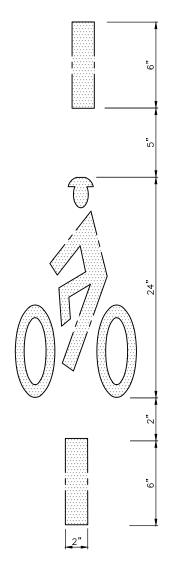

BICYCLE DETECTION MARKING DETAIL

NOT TO SCALE

NOTES:

- 1. INSTALL MARKING AT SIGNALIZED INTERSECTIONS TO INDICATE WHERE BICYCLES SHOULD STOP IN ORDER TO ACHIEVE REGULAR AND RELIABLE DETECTION BY SIGNAL EQUIPMENT.
- 2. USE MARKING ON ANY APPROACH TO A SIGNALIZED INTERSECTION WHERE LOOP DETECTORS SPECIFICALLY FOR BICYCLES ARE NOT PRESENT AND ANY APPROACH WHICH IS SHOWN A GREEN INDICATION ONLY WHEN VEHICLE LOOPS ARE ACTUATED, I.E. THE APPROACH IS NOT ON "RECALL" OPERATION.
- 3. PLACE MARKING SUCH THAT BICYCLES WHICH STOP OVER THE MARKINGS WILL ACTIVATE THE SIGNAL.
- 4. PLACE THE MARKING TO ALLOW BICYCLES GOING THROUGH TURNING RIGHT, OR TURNING LEFT TO ACTIVATE THE SIGNAL.
- 5. MARKINGS ARE NOT NECESSARY IN EXCLUSIVE LEFT TURN LANES OF APPROACHES THAT ARE OPERATED BOTH (1) ON RECALL AND (2) IN PERMISSIVE ONLY MODE.
- 6. IF AN APPROACH AS MULTIPLE LANES SERVING THROUGH MOVEMENTS AND/OR MULTIPLE LANES SERVING THE SAME TURNING MOVEMENT, ONLY THE RIGHTMOST OF SUCH MULTIPLE LANE GROUPS SHALL BE MARKED.
- 7. WHERE MULTIPLE LOOPS ARE PRESENT IN A SINGLE LANE, MARKINGS SHALL BE PLACED AS CLOSE TO THE STOP BAR AS POSSIBLE.
- 8. IN GENERAL, MARKING SHALL BE PLACED OVER THE RIGHT EDGES OF SQUARE LOOPS OR CONGRUENT WITH A LINE TANGENT TO THE RIGHTMOST POINT ON THE EDGE OF A CIRCULAR LOOP.
- 9. IN GENERAL, BICYCLE MARKINGS ARE NOT NEEDED ON APPROACHES WHERE VIDEO DETECTION IS IN PLACE, AS LONG AS BICYCLES CAN STOP BE DETECTED REGULARLLY AS RELIABLY BY STOPPING AT THE STOP BAR IN THE MIDDLE OF THE LANE.
- 10 MATERIAL SHALL BE TYPE A THERMOPLASTIC MATERIAL
- 11 SEE ALSO 2009 MANUAL ON UNIFORM TRAFFIC CONTROL DEVICES SECTION 9C.05: RCW 46.61.710; 2004 STANDARD HIGHWAY SIGNS . PAGE 10-17.



NOTES:

- 1. BIKE LANE SYMBOLS MATERIAL SHALL BE 90 MILL, PREFORMED, SKID RESISTANT THERMOPLASTIC.
- 2. BICYCLE SYMBOLS FACES ROADWAY CENTERLINE.

STANDARD DETAIL BICYCLE LANE MARKINGS



INI IAL	AJS	AJS AJS TB	AJS TB	AJS TB	AJS TB	AJS TB
	01/01/2022 AJS	AJS	AJS	AJS	AJS	AJS
	022	01/01/2022 AJ 03/31/2023 JTB	022 A	022 A	0222 A	022 1
1/2022		1/202	1/202;	1/202.	1/202.	1/202/
01/	, ;; ,	5/31/	/16/5	/18/5	15/5	7
6	į	જ	05/	02/	02/	005/
			Œ	ÆD	Q.	Q.
			DATE APPROVED	\ \ \ \	₩ 20 1	\ \delta \delta \ \d
			APP.	APP	AP ™	APP 1
CHECKED			Ψ	Į.	l e l s	l è l S
Ï			PA	DAI	DAT	TEM DATE
						1 - 18
	_	_			<u> </u>	
					CIFIC	OIFIC
		CAW		ж	CAW DATE A	AW SPECIFIC

SCALE: AS SHOWN DA

DESIGNED PRAWN CH

APPROVED BY

STANDARD SPECIFICAT

R-550A

PAGE






R-550B


PAGE 2 OF 4

- NO PARKING BIKE LANE SIGN R7-9 500-1000' SPACING (AS DIRECTED BY PUBLIC WORKS) CURB RETURN


- 1. SEE MUTCD FOR MORE INFORMATION AND SPECIFICATIONS.
- 2. PER SEC. 9B.04 2009 MUTCD, DO NOT USE R3-17 SIGNS.
- 3. BICYCLIST SYMBOLS PER R-550A.
- 4. LONG LINE MARKINGS SHALL BE PAVEMENT MARKING MATERIAL PER SECTION 9.34.1 TYPE D MMA
- 5. TRANSVERSE AND SYMBOL MARKINGS SHALL BE PAVEMENT MARKING MATERIAL PER SECTION 9-34.1 TYPE A.

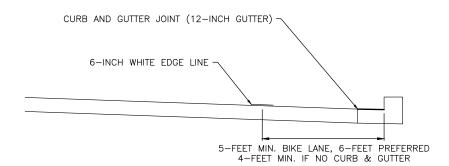

(MEASURED TO FACE OF CURB OR CENTER OF STRIPE) BICYCLE LANE WITHOUT PARKING

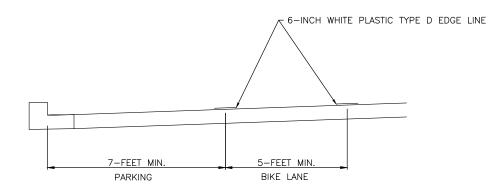


(MEASURED TO FACE OF CURB OR CENTER OF STRIPE) BICYCLE LANE WITH PARKING

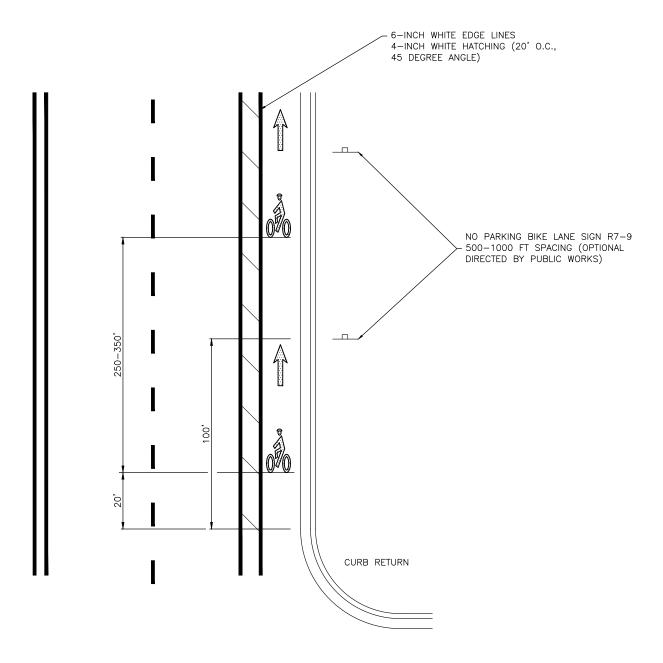

CURB AND GUTTER JOINT (12" GUTTER) 6-INCH WHITE EDGE LINE 2' MIN. BUFFER 5' MIN. BIKE LANE

BUFFERED BICYCLE LANE WITHOUT PARKING

(MEASURED TO FACE OF CURB OR CENTER OF STRIPE)

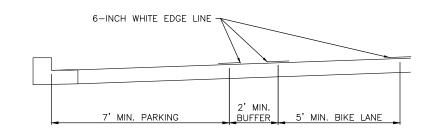

BICYCLE LANE WITH PARKING

(MEASURED TO FACE OF CURB OR CENTER OF STRIPE)

NOTES:

1. SEE MUTCD FOR MORE INFORMATION AND SPECIFICATIONS

- 2. PER SEC. 9B.04 2009 MUTCD, DO NOT USE R3-17 SIGNS.
- 3. BICYCLIST SYMBOLS PER R-550A.
- 4. LONG LINE MARKINGS SHALL BE PAVEMENT MARKING MATERIAL PER SECTION 9.34.1 TYPE D MMA.
- 5. TRANSVERSE AND SYMBOL MARKINGS SHALL BE PAVEMENT MARKING MATERIAL PER SECTION 9-34.1 TYPE A.

STANDARD DETAIL TYPICAL BUFFERED BICYCLE LANE




	DATE DRAWN	REVISIONS	SNS	
	10/05/2020	DATE	INITIAL	
	CHECKED	01/01/2022	AJS	
^		03/31/2023	JTB	
	DATE APPROVED			
ECIFI(ECIFICATIONS			

DAT	10	H		DAT	SATIC
SCALE: AS SHOWN		DESIGNED DRAWN	CAW	APPROVED BY	STANDARD SPECIFICATIO
			DE.	TAIL I	٧٥.

R-550C

PAGE

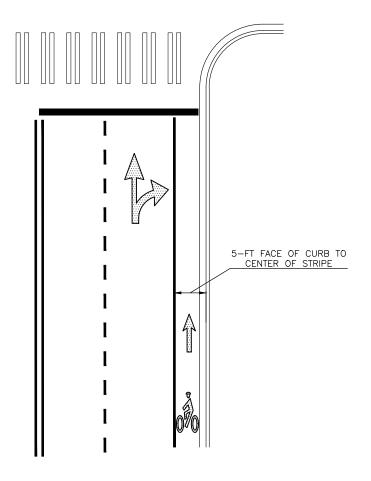


TYPICAL RIGHT-THROUGH LANE

(BICYCLE LANE CONTINUES THROUGH INTERSECTION)


NOTES:

SEE MUTCD FOR MORE INFORMATION AND SPECIFICATIONS.

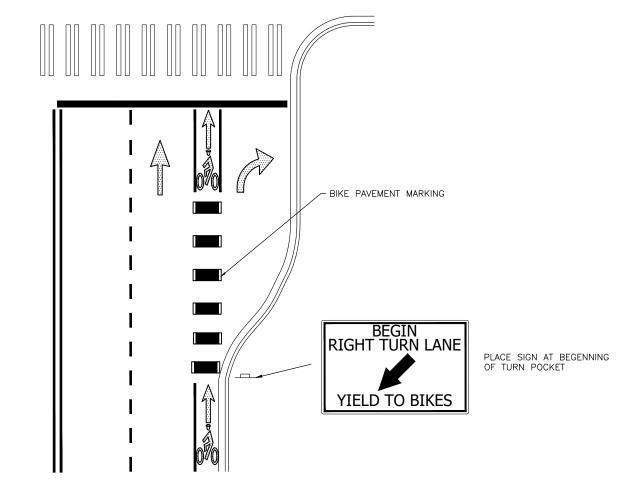

TYPICAL RIGHT TURN POCKET

(BICYCLE LANE CONTINUES THROUGH INTERSECTION)

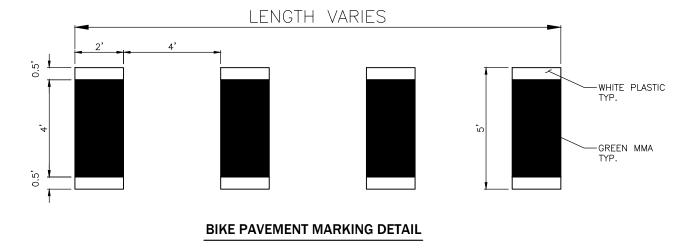

STANDARD DETAIL TYPICAL BICYCLE LANE AT INTERSECTION

City of Wenatchee

NS	INITIAL	AJS	JTB				
REVISIONS	DATE	01/01/2022	03/31/2023				
DATE DRAWN	10/05/2020	CHECKED		DATE APPROVED	SATIONS		
SHOWN		DRAWN	CAW	37	STANDARD SPECIFICATIONS		
SCALE: AS SHOWN		DESIGNED		APPROVED BY	STAN		

R-550D

PAGE **4 OF 4**



RESIDENTIAL DRIVEWAYS

DISTANCE

325 FEET

250 FEET

200 FEET

150 FEET

SPEED LIMIT

40 MPH

35 MPH

30 MPH

25 MPH



STANDARD DETAIL

SIGHT DISTANCE


SETBACK



R-600


PAGE

1 OF 1

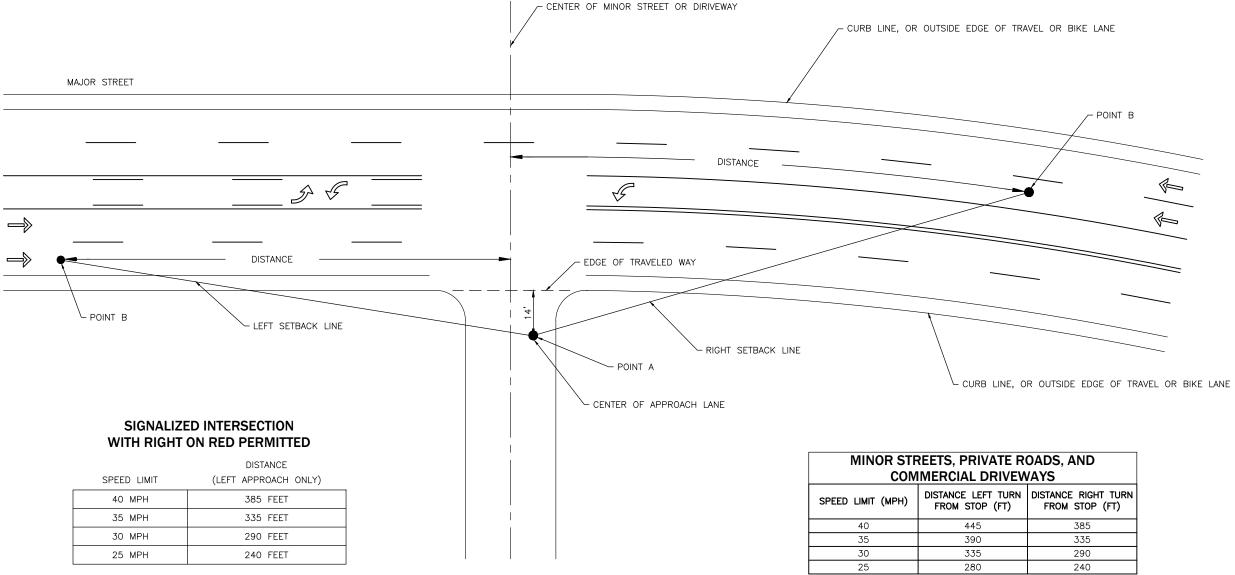

MINOR STREET, PRIVATE ROAD, **COMMERCIAL AND RESIDENTIAL DRIVEWAYS**

1. FOR RESIDENTIAL DRIVEWAYS, DISTANCE OF POINT A FROM EDGE OF TRAVEL LANE IS 10-FT.

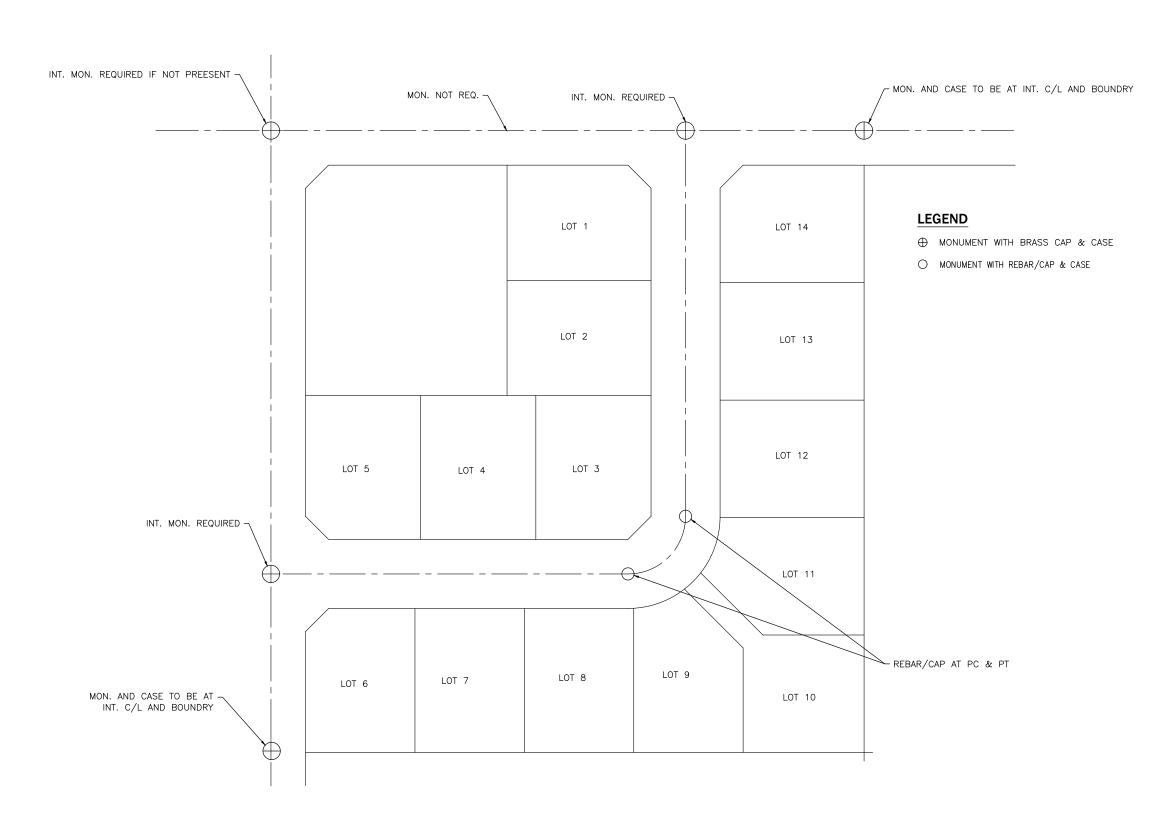

MONUMENT PLACEMENT N.T.S.

STANDARD DETAIL **PLACEMENT** MONUMENT



•					
CAW	AJS				
10/26/2020	01/01/2022				
		SOVED			

DETAIL NO. R-700

PAGE 1 OF 1

STANDARD DETAIL MONUMENT CASE

STAN STAN MON







R-710

PAGE **1 OF 1**

ALTERNATE MONUMENT CASE MAY BE USED WITH CITY ENGINEERS

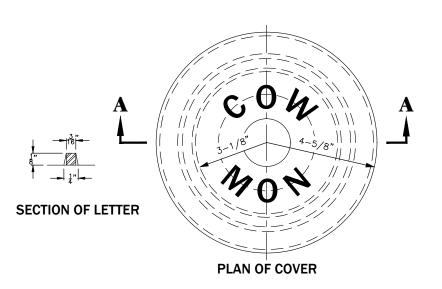


STANDARD MONUMENT CASE

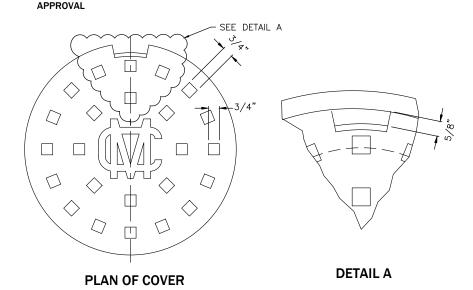


NOTES:


- 1. 2-INCH BRASS CAP OR REBAR AND CAP ARE ACCEPTABLE FOR USE IN MONUMENT CASE.
- 2. WHEN PLACING MONUMENTS IN PAVED SURFACES, HEIGHT OF CASE OR COVER SHALL BE NO LESS THAN ZERO AND NO MORE THAN \$\frac{1}{8}\$-INCH BELOW FINISHED GRADE.
- 3. MEETS CITY OF WENATCHEE AND WHASHINGTON STANDARD SPECIFICATIONS FOR MONUMENT CASE AND COVER. SUITABLE FOR HEAVY TRAFFIC LOADING. UNIT WEIGHT 39LBS.
- 4. MONUMENTS SHALL BE PROTECTED FROM DAMAGE ACCORDING TO R.C.W 58.24.040, AND R.C.W. 58.09.130. IF MONUMENTS ARE TO BE DISTURBED, THEN W.A.C. 332-120 APPLIES.
- 5. CASTING SHALL BE GRAY IRON ASATM A48, AASHTO M 105, CLASS 30.
- 6. COVER AND SEAT SHALL BE MACHINED FOR PERFECT CONTACT AROUND CIRCUMFRENCE AND FULL WIDTH OF BEARING SURFACE.
- 7. APPROXIMATE WEIGHTS, STANDARD. CASE — 60 LBS COVER — 19 LBS TOTAL — 79 LBS
- 8. CONCRETE SHALL BE CLASS 3000.
- 9. PIPE MUST BE INSTALLED PRIOR TO ROAD SURFACING.

CASE 1: 2-INCH BRASS CAP

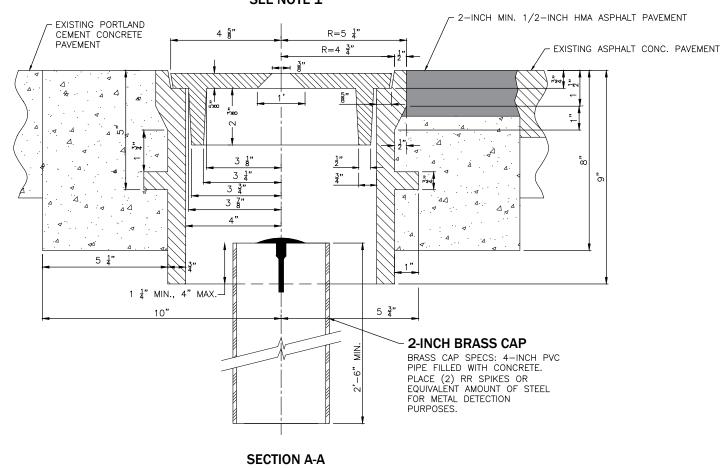

CASE 2: REBAR AND CAP SEE NOTE 1

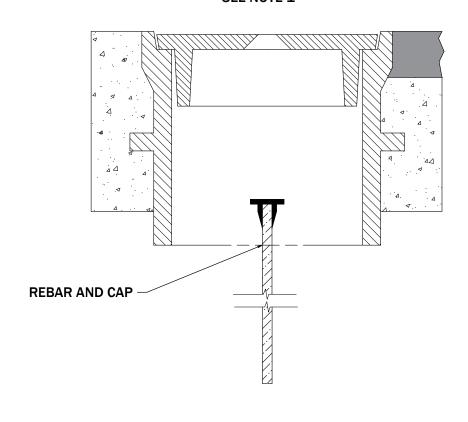

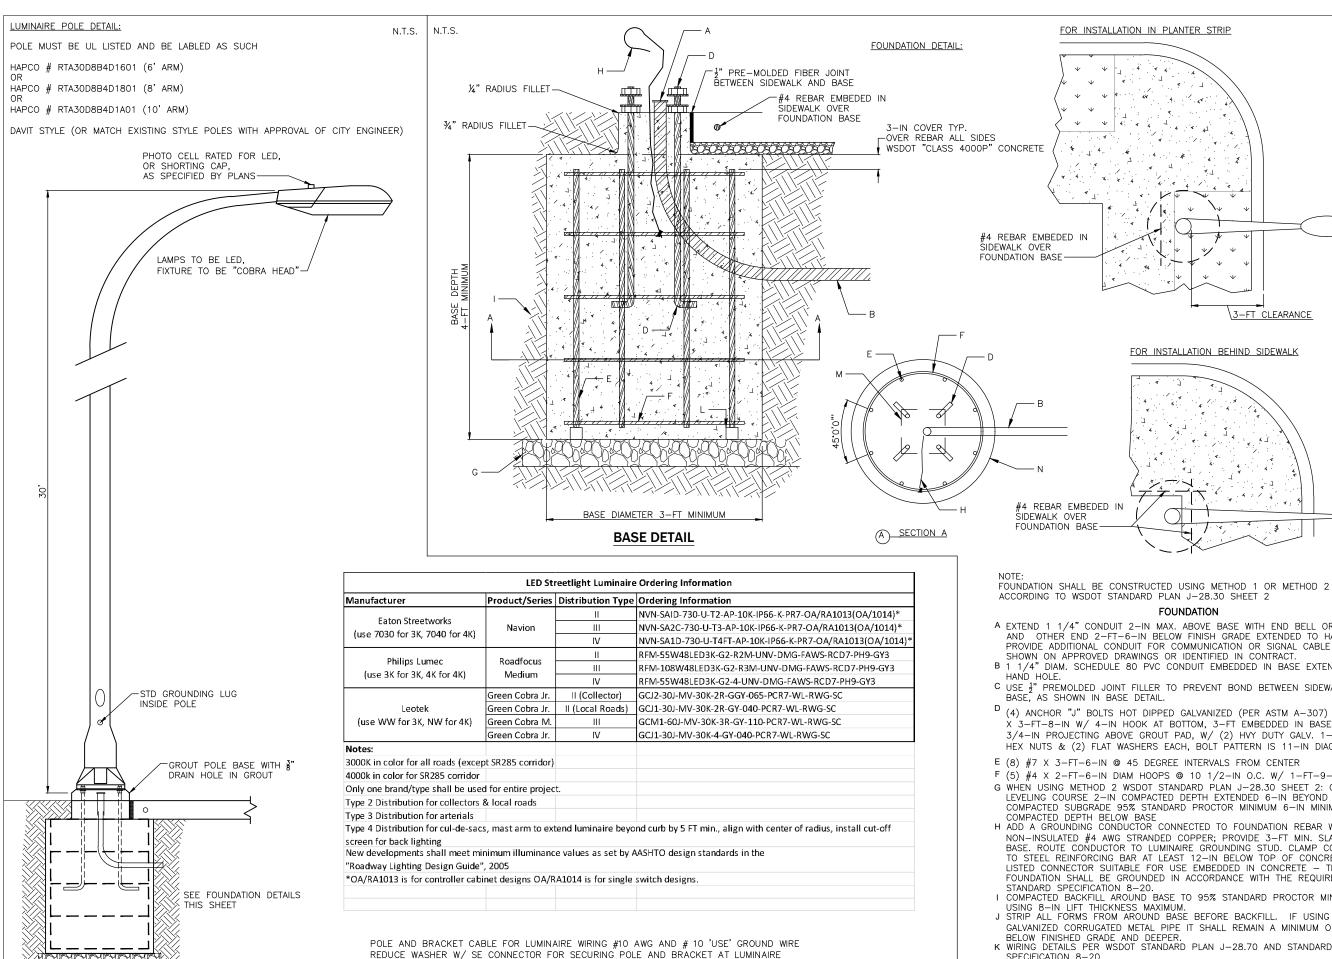

FUSED QUICK DISCONNECTS AT TOP OF BASE ACCESSED VIA HANDHOLE IN POLE.

SEE WSDOT STANDARD PLAN J-28.70 FOR STEEL LIGHT STANDARD WIRING DETAILS

POLE DETAIL 8 **LUMINAIR** STANDARD LIGHT BASI

iot To

FOUNDATION A EXTEND 1 1/4" CONDUIT 2-IN MAX. ABOVE BASE WITH END BELL OR BUSHING AND OTHER END 2-FT-6-IN BELOW FINISH GRADE EXTENDED TO HAND HOLE. PROVIDE ADDITIONAL CONDUIT FOR COMMUNICATION OR SIGNAL CABLE WHERE

\3-FT CLEARANCE

FOR INSTALLATION BEHIND SIDEWALK

SHOWN ON APPROVED DRAWINGS OR IDENTIFIED IN CONTRACT B 1 1/4" DIAM. SCHEDULE 80 PVC CONDUIT EMBEDDED IN BASE EXTENDED TO

C USE 3" PREMOLDED JOINT FILLER TO PREVENT BOND BETWEEN SIDEWALK AND BASE, AS SHOWN IN BASE DETAIL

 $^{\mathrm{D}}$ (4) ANCHOR "J" BOLTS HOT DIPPED GALVANIZED (PER ASTM A-307) 1-IN DIAM X 3-FT-8-IN W/ 4-IN HOOK AT BOTTOM, 3-FT EMBEDDED IN BASE, AND 2 3/4-IN PROJECTING ABOVE GROUT PAD, W/ (2) HVY DUTY GALV. 1-IN N.C. HEX NUTS & (2) FLAT WASHERS EACH, BOLT PATTERN IS 11-IN DIAGONAL.

E (8) #7 X 3-FT-6-IN @ 45 DEGREE INTERVALS FROM CENTER

F (5) #4 X 2-FT-6-IN DIAM HOOPS @ 10 1/2-IN O.C. W/ 1-FT-9-IN LAPS

G WHEN USING METHOD 2 WSDOT STANDARD PLAN J-28.30 SHEET 2: COMPACTED LEVELING COURSE 2-IN COMPACTED DEPTH EXTENDED 6-IN BEYOND BASE ON COMPACTED SUBGRADE 95% STANDARD PROCTOR MINIMUM 6-IN MINIMUM

COMPACTED DEPTH BELOW BASE H ADD A GROUNDING CONDUCTOR CONNECTED TO FOUNDATION REBAR WITH NON-INSULATED #4 AWG STRANDED COPPER; PROVIDE 3-FT MIN. SLACK ABOVE BASE. ROUTE CONDUCTOR TO LUMINAIRE GROUNDING STUD. CLAMP CONDUCTOR TO STEEL REINFORCING BAR AT LEAST 12-IN BELOW TOP OF CONCRETE WITH LISTED CONNECTOR SUITABLE FOR USE EMBEDDED IN CONCRETE - THE FOUNDATION SHALL BE GROUNDED IN ACCORDANCE WITH THE REQUIREMENTS OF STANDARD SPECIFICATION 8-20.
COMPACTED BACKFILL AROUND BASE TO 95% STANDARD PROCTOR MINIMUM,

USING 8-IN LIFT THICKNESS MAXIMUM.

J STRIP ALL FORMS FROM AROUND BASE BEFORE BACKFILL. IF USING GALVANIZED CORRUGATED METAL PIPE IT SHALL REMAIN A MINIMUM OF 6" BELOW FINISHED GRADE AND DEEPER.
K WIRING DETAILS PER WSDOT STANDARD PLAN J-28.70 AND STANDARD

SPECIFICATION 8-20.

PRE-CAST CONCRETE BLOCK SPACERS ATTACHED TO REBAR (3 MIN) TO PROVIDE 3-IN CLEAR FROM VERTICAL BARS TO SOIL

M MONOLITHIC 12" SQUARE

N OUTER DIAMETER CONCRETE BASE


_	DATE DRAWN	REVISIONS	NS	
	3/23/2015	DATE	INITIAL	
	CHECKED	5/11/2015	RDH	Ŧ
	DMN	11/2/2017	JBV	
	DATE APPROVED	1/28/2018	JBV	
		4/24/2018	JBV	
\simeq	ICATIONS	01/01/2022	AJS	
- L	NOILV	03/31/2023	JTB	
<u> </u>	FIC SIGNAL SYS.			
₹	AL, ELECTRICAL			

DETAIL NO R-800

AS

PAGE 1 OF 1

3223

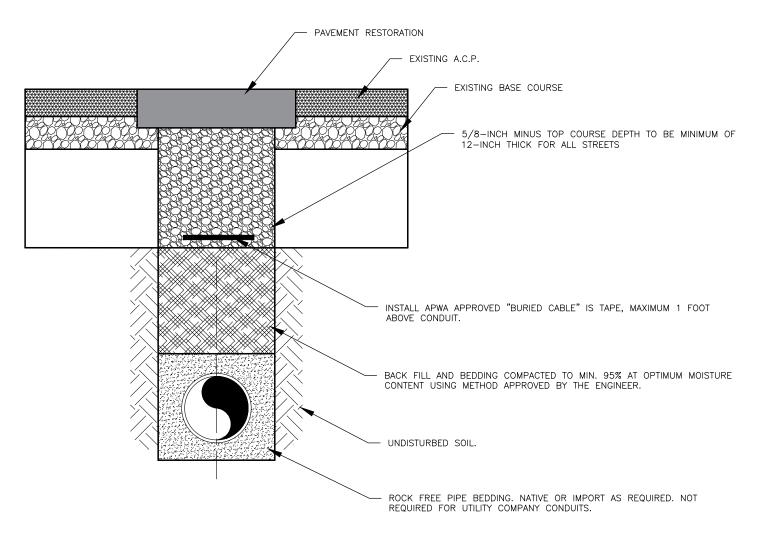

- TRENCH DEPTH SHALL PROVIDE A MINIMUM COVER OF 24-INCH OVER TOP OF CONDUIT.
 COMMUNICATION AND P.U.D. TO BE MIN. 30-INCH AT NON CURBED STREET CROSSINGS OR AS REQUIRED BY THE PERMIT.
- 2. MINIMUM ONE-WAY TRAFFIC TO BE MAINTAINED ACCORDING TO APPROVED TRAFFIC CONTROL PLAN.
- 3. ALL ROADWAY APPURTENANCES TO BE PROTECTED AND ROAD SIGNS LEFT AS FOUND.
- 4. PAVEMENT REPAIR TO BE MADE WITHIN 24 HOURS OF TRENCH BACKFILL.
- 5. PERMIT REQUIRED ON ALL PROJECTS, EXCEPT CONTRACT ADMINISTERED BY THE CITY ENGINEER DEPT. AND EXCEPT AS SPECIFIED BY SOME FRANCHISES.

STREET CUT AND PATCH DETAIL FOR TYPICAL TRAFFIC SIGNAL, STREET LIGHTING AND UTILITY COMPANY CONDUITS


STANDARD DETAIL STREET LIGHT CONDUIT CROSSING




OWN	DATE DRAWN	REVISIONS	NS	
	3/23/2015	DATE	INITIAL	
)RAWN	CHECKED	01/01/2022 AJS	AJS	
RDH	DMN	03/31/2023	JTB	
	DATE APPROVED			
RD SPECIFICATIONS	CATIONS			
RE EXCAV.				
ION MIL.				

R-810

PAGE

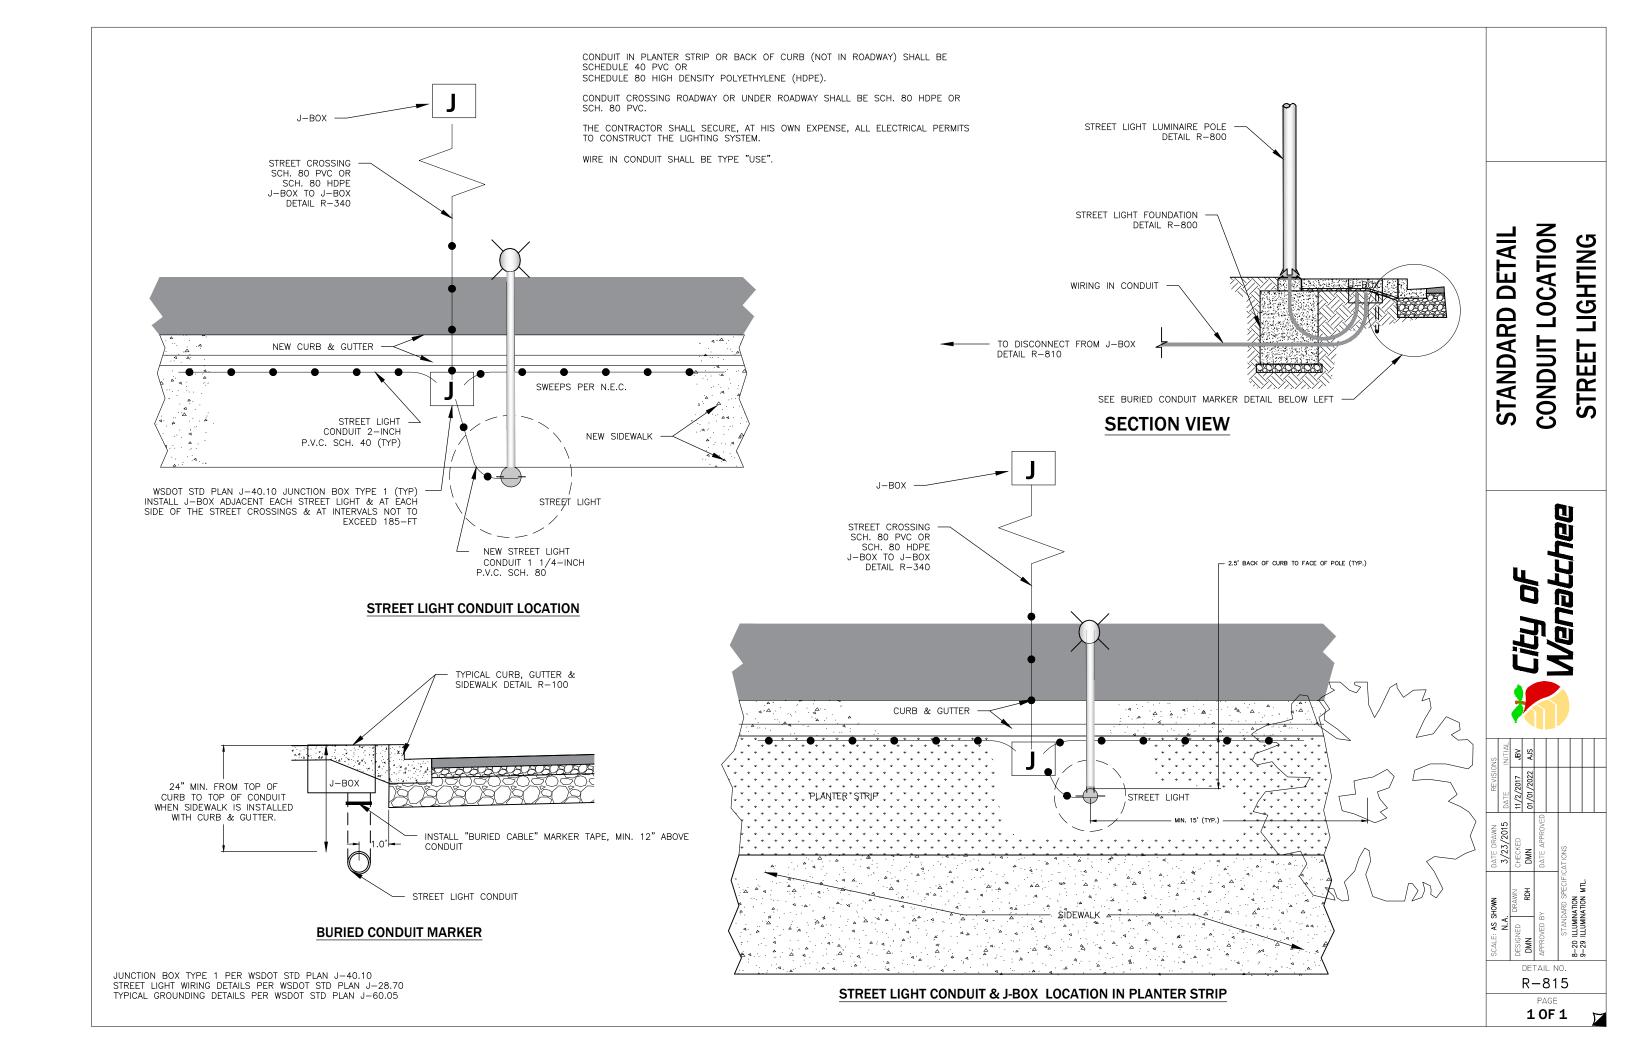

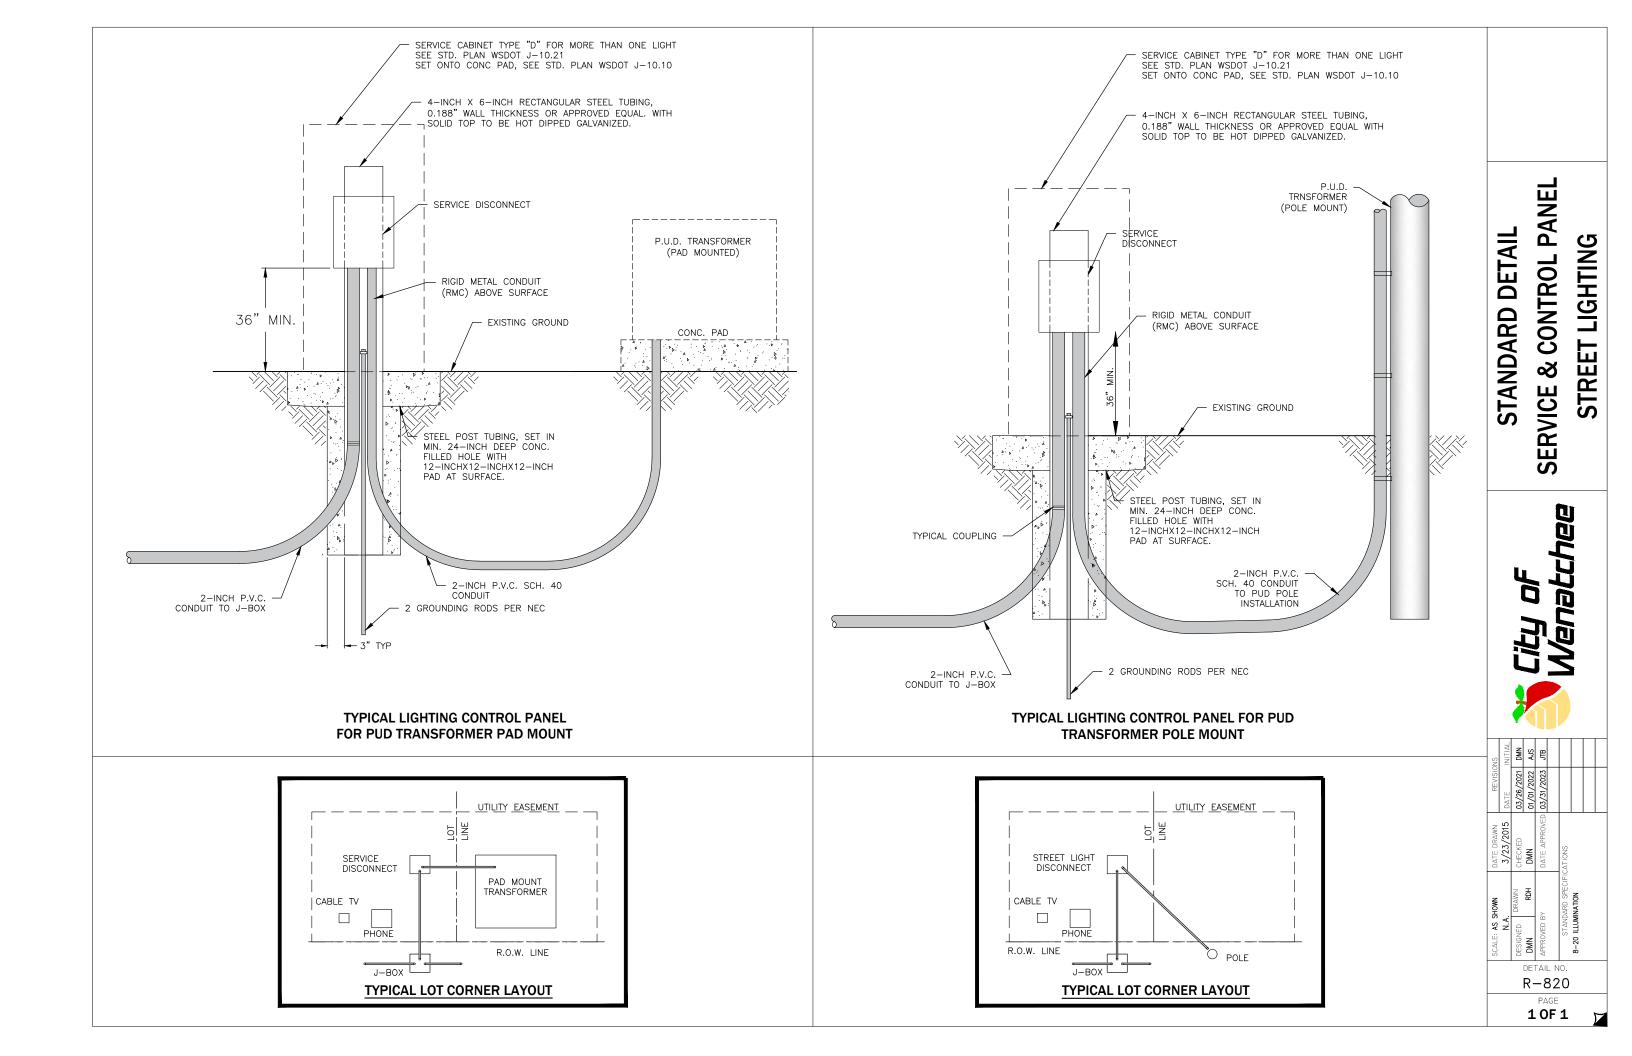


ELEVATION SECTION

COMPONENT SCHEDULE

- METERBASE: 100 AMP, 4 JAW, B-LINE #114TB, SAFETY SOCKET TYPE, 5TH JAW KIT
- PANELBOARD: 120/240 VAC, 100 AMP BUS, 1 PHASE, 3 WIRE, COPPER BUS, 18 CKT EATON 100A 2 POLE MAIN BREAKER, BAB2100 (BACK-FED) EATON BAB BOLT-ON BREAKERS:
 - 2 20 ILLUMINATION BRANCH A, B 1 50 SIGNAL BRANCH

 - $1 \frac{20}{1}$ BRANCH, GFR
 - 1 15 BRANCH, CONTROL BRANCH 11 1 POLE SPACE ONLY
- 3 CONTRACTOR: LIGHTING RATED, 30 AMP, 4 POLE, 120 VAC COIL:1 REQUIRED
- 4 DUPLEX RECEPTACLE, 120 VAC, GFI
- 5 PHOTO-CELL BYPASS SWITCH, SPST, 15 AMP, 277 VAC
- $\fbox{6}$ PHOTO ELECTRIC CELL: 1800 WATT, 120 VAC, TWIST LOCK, ALR #SST-IES WITH 6"x6"x6" WIRE MESH GUARD.

120/240VAC, 1 PHASE, 3 WIRE

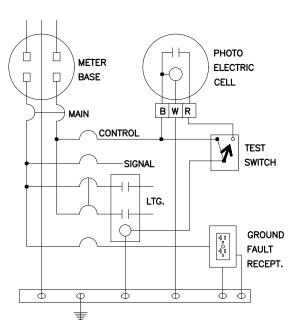

WIRING SCHEMATIC

NOTES:

- 1. SEE WSDOT STANDARD J.10.10 FOR BASE DETAILS.
- 2. SEE WSDOT STANDARD J.60.05 FOR GROUNDING DETAILS.


CABINET FOR STANDARD DETAIL **LIGHTING** STREET SERVICE




					_ !			
SNS	INITIAL	CAW						
REVISIONS	DATE	09/07/2021						
DATE DRAWN	4/01/2020	CHECKED		DATE APPROVED		ATIONS		
SHOWN		DRAWN	CAW	37		STANDARD SPECIFICATIONS		
SCALE: AS SHOWN		DESIGNED		APPROVED BY		STANI		
			DE.	ΓΔΙΙ	LN	0.		

R-830

PAGE

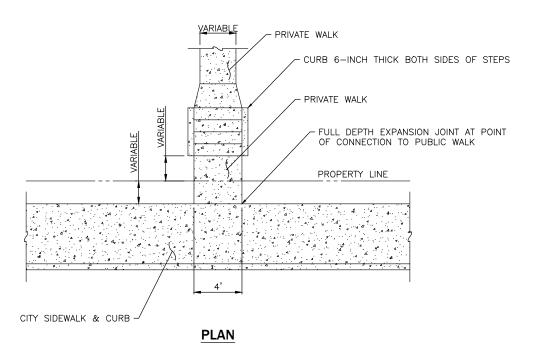

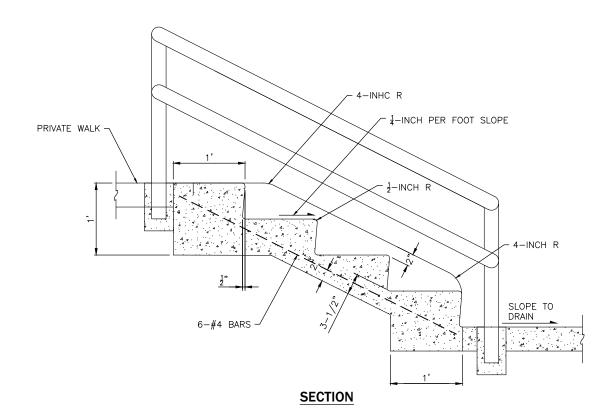

- 1. STEPS SHALL BE 4-FEET 0-INCH WIDE, CURB TO CURB, PLUS 6-INCH CURBS ON EACH SIDE.
- 2. CEMENT CONCRETE SHALL BE CLASS 4000 TROWEL FINISH.
- 3. NUMBER OF STEPS SHALL SUIT INDIVIDUAL CONDITIONS, WITH TREAD AND RISER DIMENSIONS TO SUIT THE GRADE.
- 4. RISERS SHALL BE 5-INCH MINIMUM, 7-INCH MAXIMUM: TREAD SHALL BE 11-INCH MINIMUM, 12-INCH MAXIMUM.
- 5. HANDRAIL REQUIRED ON BOTH SIDES PER BUILDING CODE STANDARDS.
- 6. HANDRAIL MAY NOT ENCROACH INTO PUBLIC SIDEWALK


STANDARD DETAIL CEMENT CONCRETE STEPS




		Y	_				_
SN	INITIAL	AJS	E B				
REVISIONS	DATE	01/01/2022	03/31/2023 JTB				
DATE DRAWN	0/23/2020	CHECKED		DATE APPROVED	CIFICATIONS		
					E E		

DETAIL NO.
R-900

PAGE

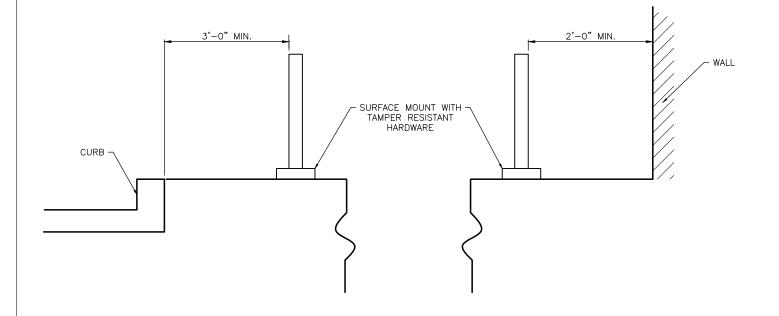

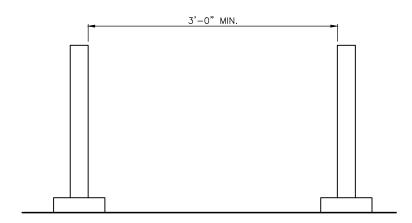

- 1. UNLESS OTHERWISE APPROVED, BICYCLE PARKING RACKS SHALL BE "INVERTED U TYPE" CYCLE-SAFE U/2 BLACK PLASTISOL COATED BY MANUFACTURER OR APPROVED EQUIVALENT. OTHER RACKS MAY BE ALLOWED BUT MUST MEET THE FOLLOWING FUNCTIONAL REQUIREMENTS:
 - SUPPORT THE FRAME OF A BICYCLE IN TWO PLACES AND PREVENT THE BICYCLE FROM TIPPING OVER.
 - ALLOW THE FRAME AND ONE WHEEL TO BE LOCKED TO THE RACK WHEN BOTH WHEELS ARE LEFT ON THE BIKE.
 - ALLOW THE FRAME AND BOTH WHEELS TO BE LOCKED TO THE RACK IF THE FRONT WHEEL IS REMOVED.
 - ALLOW THE USE OF EITHER A CABLE OR U-SHAPED LOCK.
 - BE SECURELY ANCHORED BY SURFACE MOUNT.
 - BE USABLE BY BIKES WITH NO KICKSTAND.
 - BE USABLE BY BIKES WITH WATER BOTTLE CAGES.
 - ${\sf -}$ BE USABLE BY A WIDE VARIETY OF SIZES AND TYPES OF BICYCLES.
 - BE COATED BY MANUFACTURER
- 2. INSTALL PER MANUFACTURER'S RECOMENDATION.

PARKING RACK STANDARD DETAIL BICYCLE





NS	INITIAL	JTB					
REVISIONS	DATE	03/31/2023					
DATE DRAWN	10/09/2020	CHECKED		DATE APPROVED	ATIONS		
SCALE: AS SHOWN		DESIGNED DRAWN	CAW	APPROVED BY	STANDARD SPECIFICATIONS		
_							_

DETAIL NO. R-950

PAGE

